


PROPOSED DEVELOPMENT - HOMEMAKER CENTRE 202 BUSHLAND DRIVE, TAREE, NSW

TOWN PLANNING APPLICATION



ARTIST IMPRESSION

SHEET NO.	SHEET TITLE	REVISION
DA001	COVER SHEET	A
DA001	EXISTING CONDITIONS	A
DA013	PROPOSED SITE PLAN	A
DA020	TENANCY 1-4 GROUND FLOOR PLAN	A
DA101	TENANCY 5-6, 16 GROUND FLOOR PLAN	A
DA102 DA103	TENANCY 7-11 GROUND FLOOR PLAN	A
DA103	TENANCY 12-15 GROUND FLOOR PLAN	
DA104	TENANCY 1-4 ROOF PLAN	A
DATTI DATTI		A
	TENANCY 7-11 POOF PLAN	
DA113	TENANCY 7-11 ROOF PLAN	A
DA114	TENANCY 12-15 ROOF PLAN	A
DA151	ELEVATIONS - SHEET 1	A
DA152	ELEVATIONS - SHEET 2	A
DA153	ELEVATIONS - SHEET 3	A
DA154	ELEVATIONS - SHEET 4	A
DA161	SECTIONS - SHEET 1	A
DA162	SECTIONS - SHEET 2	A
DA163	SECTIONS - SHEET 3	A
DA170	SIGNAGE DETAILS	A
DA171	PYLON DETAILS	A
DA201	SHADOW DIAGRAMS	Α
DA202	SHADOW DIAGRAMS	Α
DA300	PROPOSED ARTIST IMPRESSIONS	Α

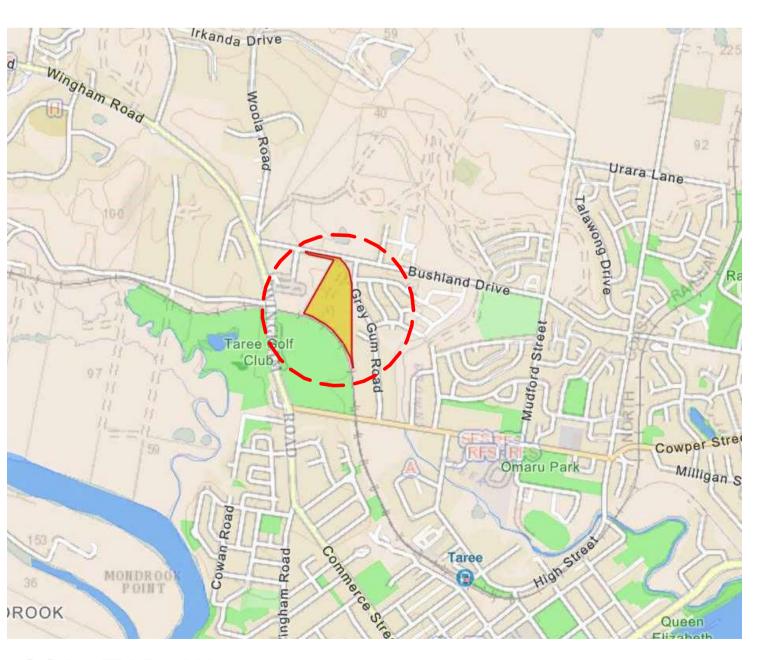

LOCALITY PLAN

ISSUE AMENDMENT
A DEVELOPMENT APPLICATION DATE CHK'D 30.05.25 WG





ISSUE AMENDMENT

A DEVELOPMENT APPLICATION

30.05.25 WG



LEGEND PROPERTY BOUNDARIES **EASEMENTS** _____ SEWER MAIN ----ELECTRICAL LINE PROPOSED CULVERT **SWALE** LANDSCAPING PROPOSED CARSPACES PROPOSED FOOTPATH PEDESTRIAN CROSSING COLUMN DOWNPIPE TREE - REFER LANDSCAPE ARCHITECTS DRAWINGS FINISH FLOOR LEVEL SUBJECT FFL TO CIVIL ENGINEERS ADVICE

DEVELOPMENT ANALYSIS TABLE SITE AREA

Area

Name

SITE BOUNDARY	85,217 m ²
AREA SCHEDULE (GR	OSS LETTABLE AREA)
TENANCY 1	1500 M ²
TENANCY 2	800 M ²
TENANCY 3	800 M ²
TENANCY 4	1,430 M ²
TENANCY 5	2,400 M ²
TENANCY 6	870 M ²
TENANCY 7	630 M ²
TENANCY 8	630 M ²
TENANCY 9	630 M ²
TENANCY 10	1,200 M ²
TENANCY 11	1,500 M ²
TENANCY 12	900 M ²
TENANCY 13	900 M ²
TENANCY 14	900 M ²
TENANCY 15	1,500 M ²
TENANCY 16	2,000 M ²
TOTAL	18,590 M ²

PARKING SCHEDULE

Comments	Carpark Number		
ACCESSIBLE	1:		
PROPOSED	479		
TOTAL	492		
BICYCLE SCHEDULE			

BICYCLE - VISITOR (TBC) TOTAL (TBC)

BICYCLE - STAFF (TBC)

ALL AREAS ARE APPROXIMATELY CALCULATED AS GROSS LEASABLE (GLA)PER METHOD OF MEASUREMENT BY PROPERTY COUNCIL OF

DESCRIPTION


GROSS LETTABLE AREA IS DETERMINED BY INCLUDING EVERYTHING WITHIN THE EXTERNAL BUILDING WALLS. IT IS CALCULATED AT EACH FLOOR LEVEL MEASURING FROM THE OUTSIDE FACE OF THE STRUCTURAL WALLS OF THE BUILDING ALIGNMENT AND THE CENTRE OF THE INTER-TENANCY WALLS OR COMMON AREAS.

THE NET LETTABLE AREA OF A BUILDING IS THE SUM OF ITS WHOLE FLOOR AREA, TAKING MEASUREMENTS FROM THE INTERNAL FINISH SURFACES OF PERMANENT INTERNAL WALLS AND THE INTERNAL FINISHED SURFACES OF DOMINANT PORTIONS OF THE PERMANENT OUTER BUILDING WALLS.


ISSUE AMENDMENT


A DEVELOPMENT APPLICATION

30.05.25 WG

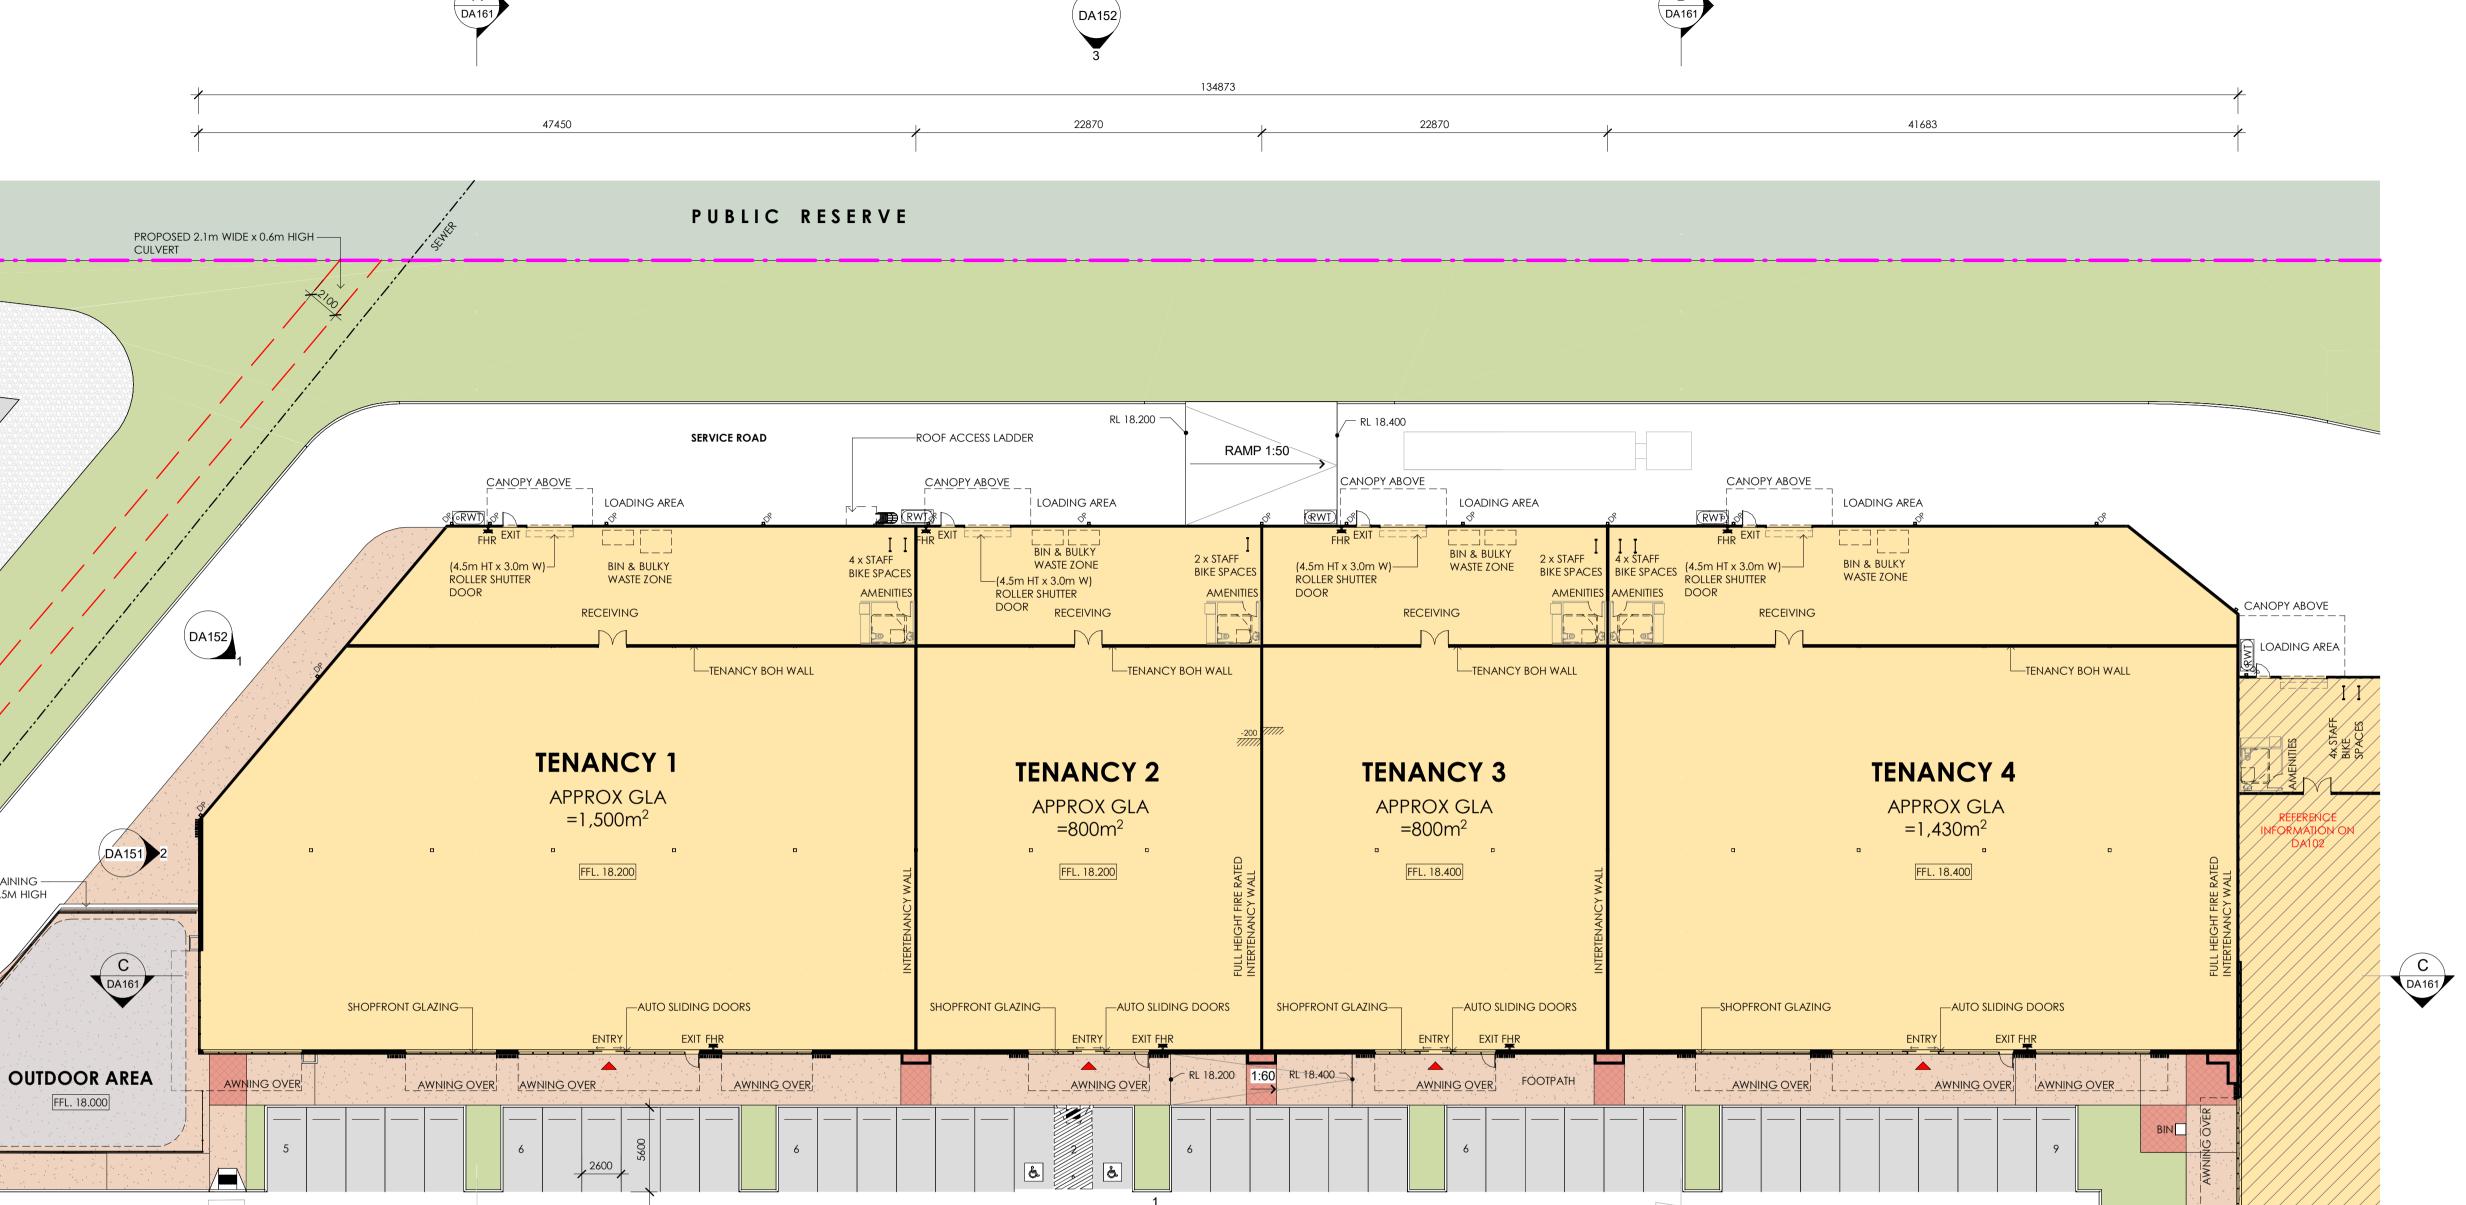

(DA151)

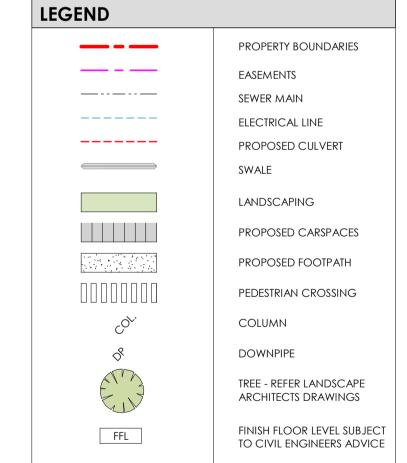

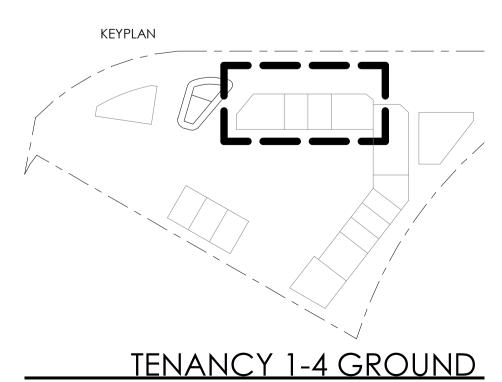

DEVELOPMENT APPLICATION

FLOOR PLAN


FILL RETAINING — WALL 1.5M HIGH


SCALE 25 1:250 @ A1


Member
Australian Institute of Architects


ISSUE AMENDMENT
A DEVELOPMENT APPLICATION

DATE CHK'D 30.05.25 WG

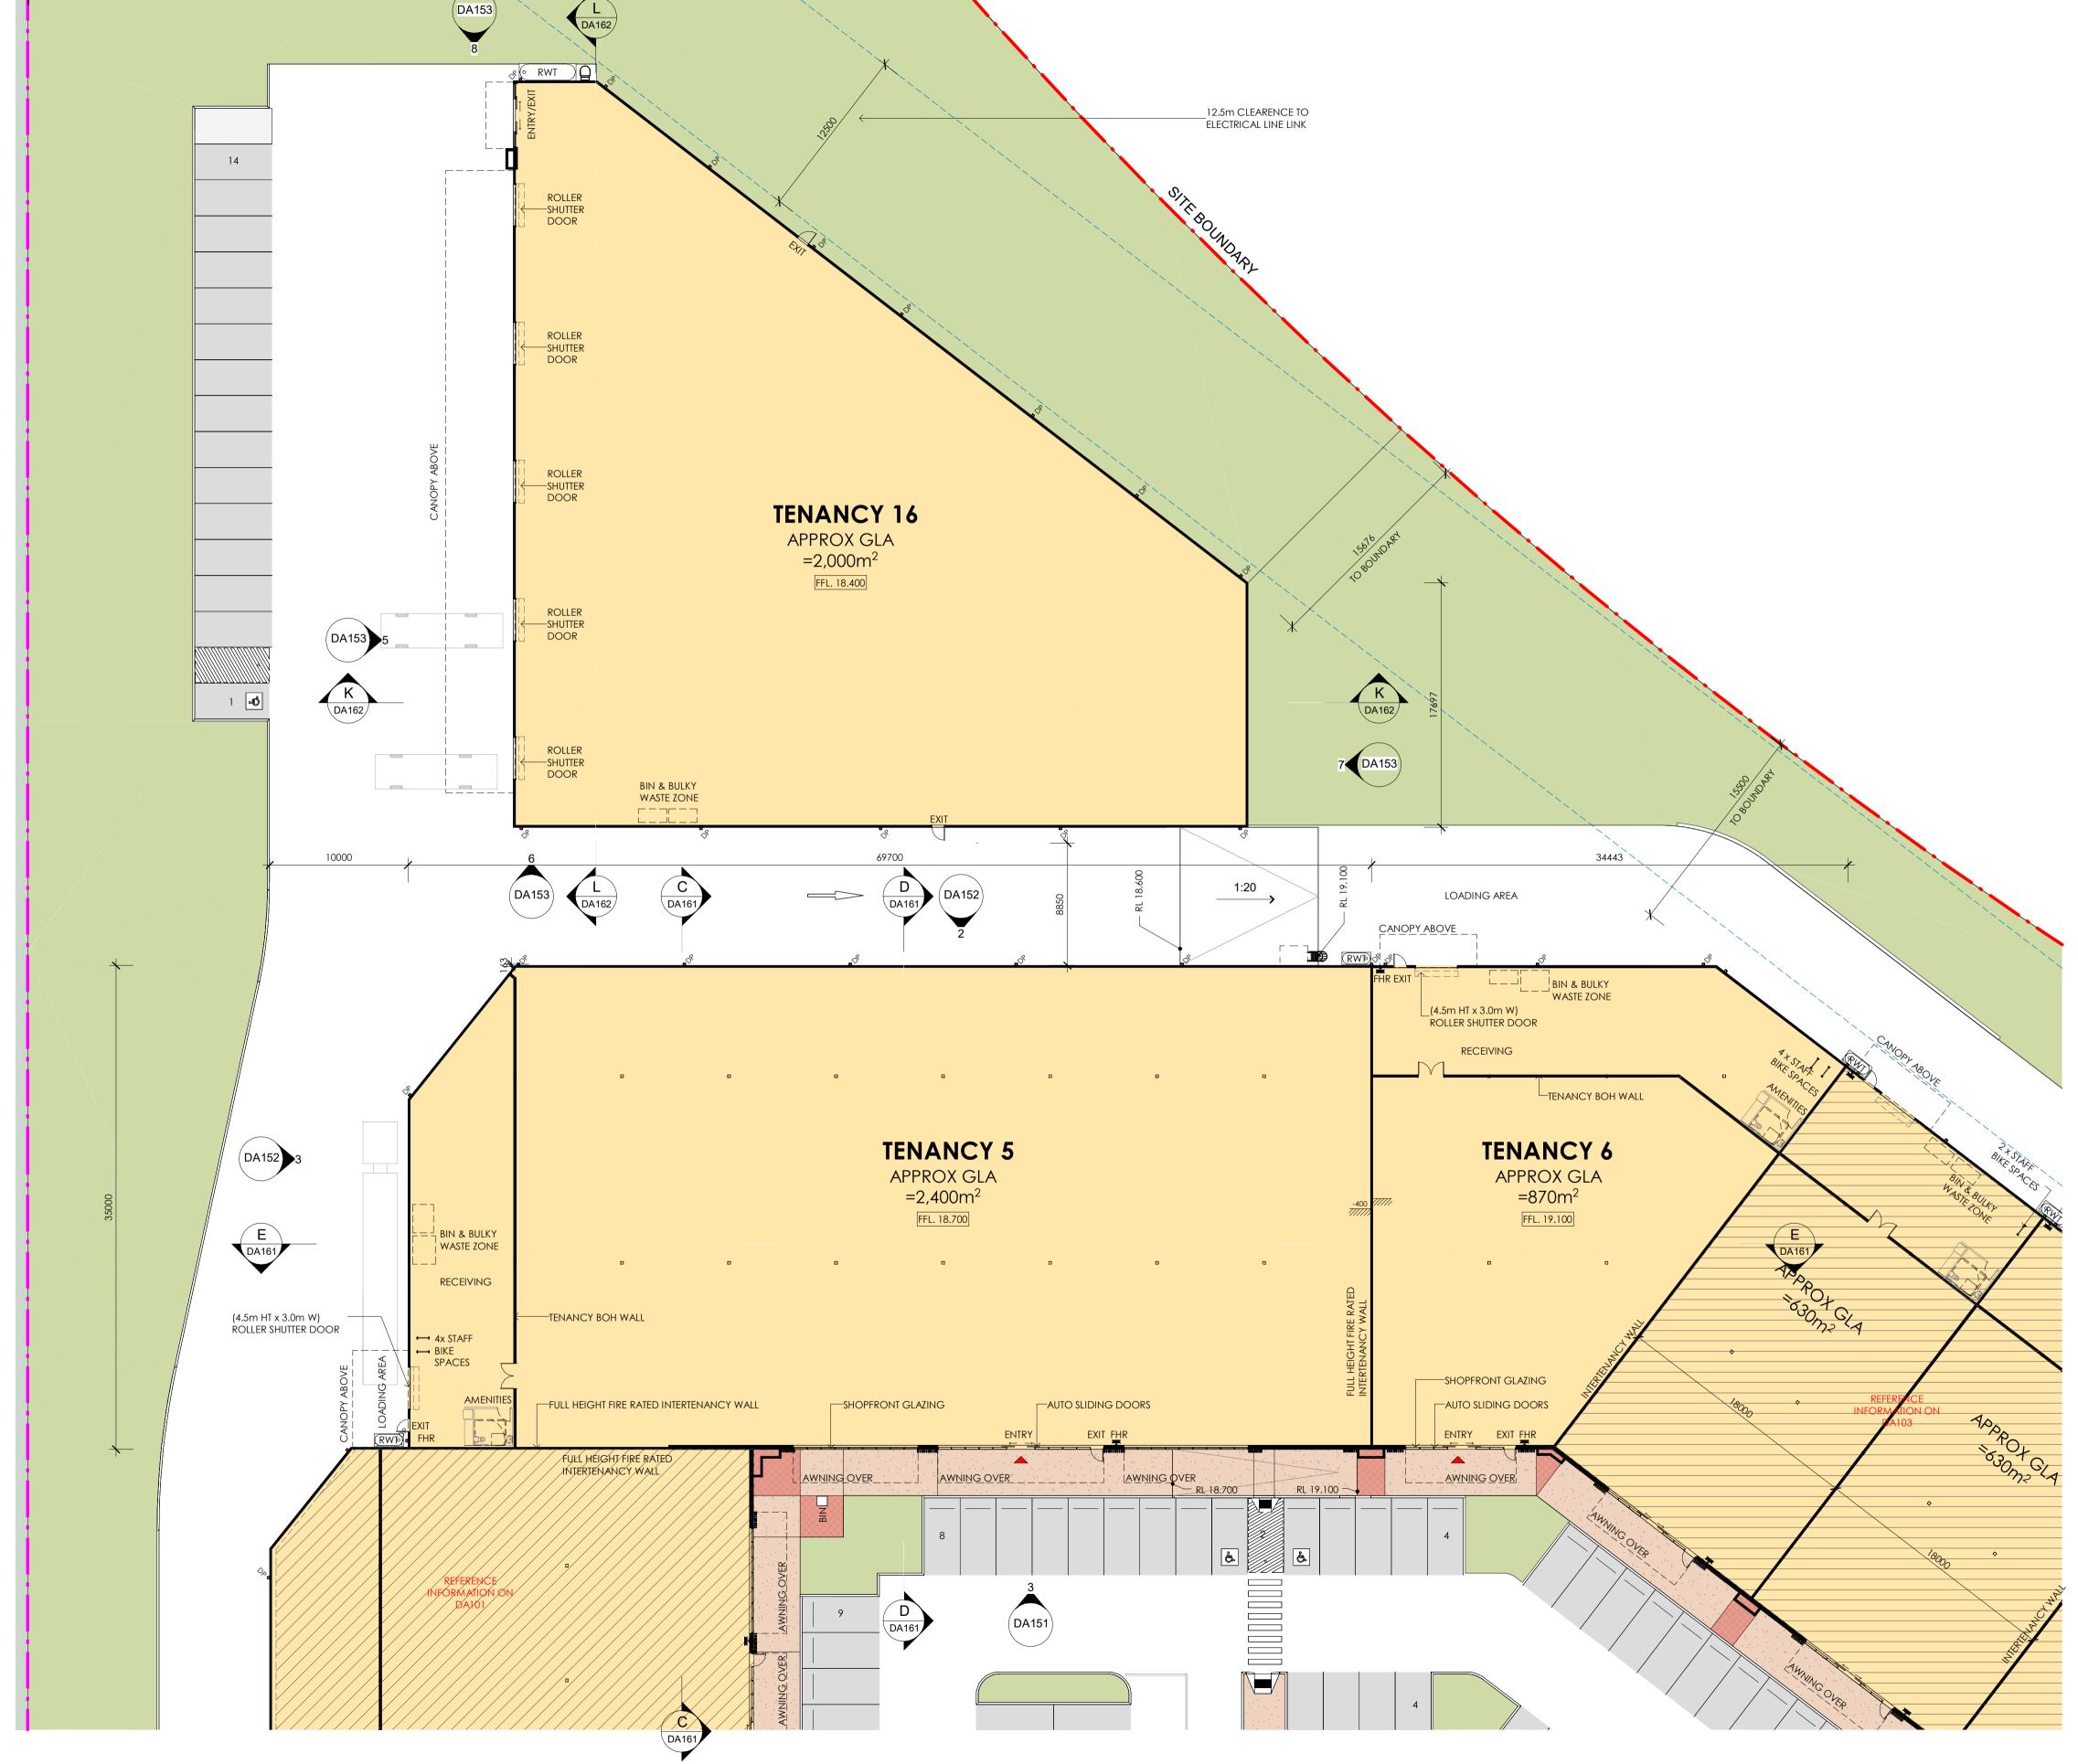

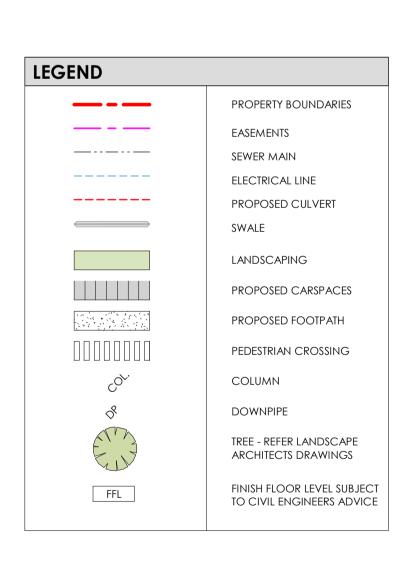


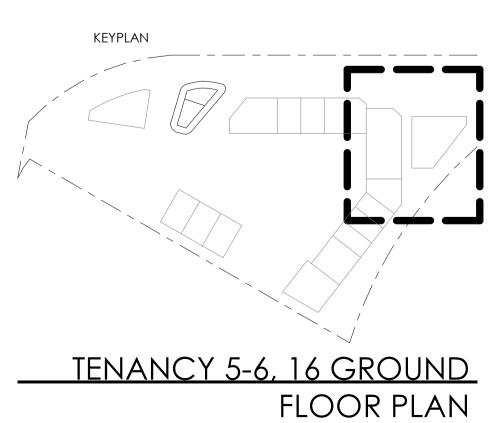


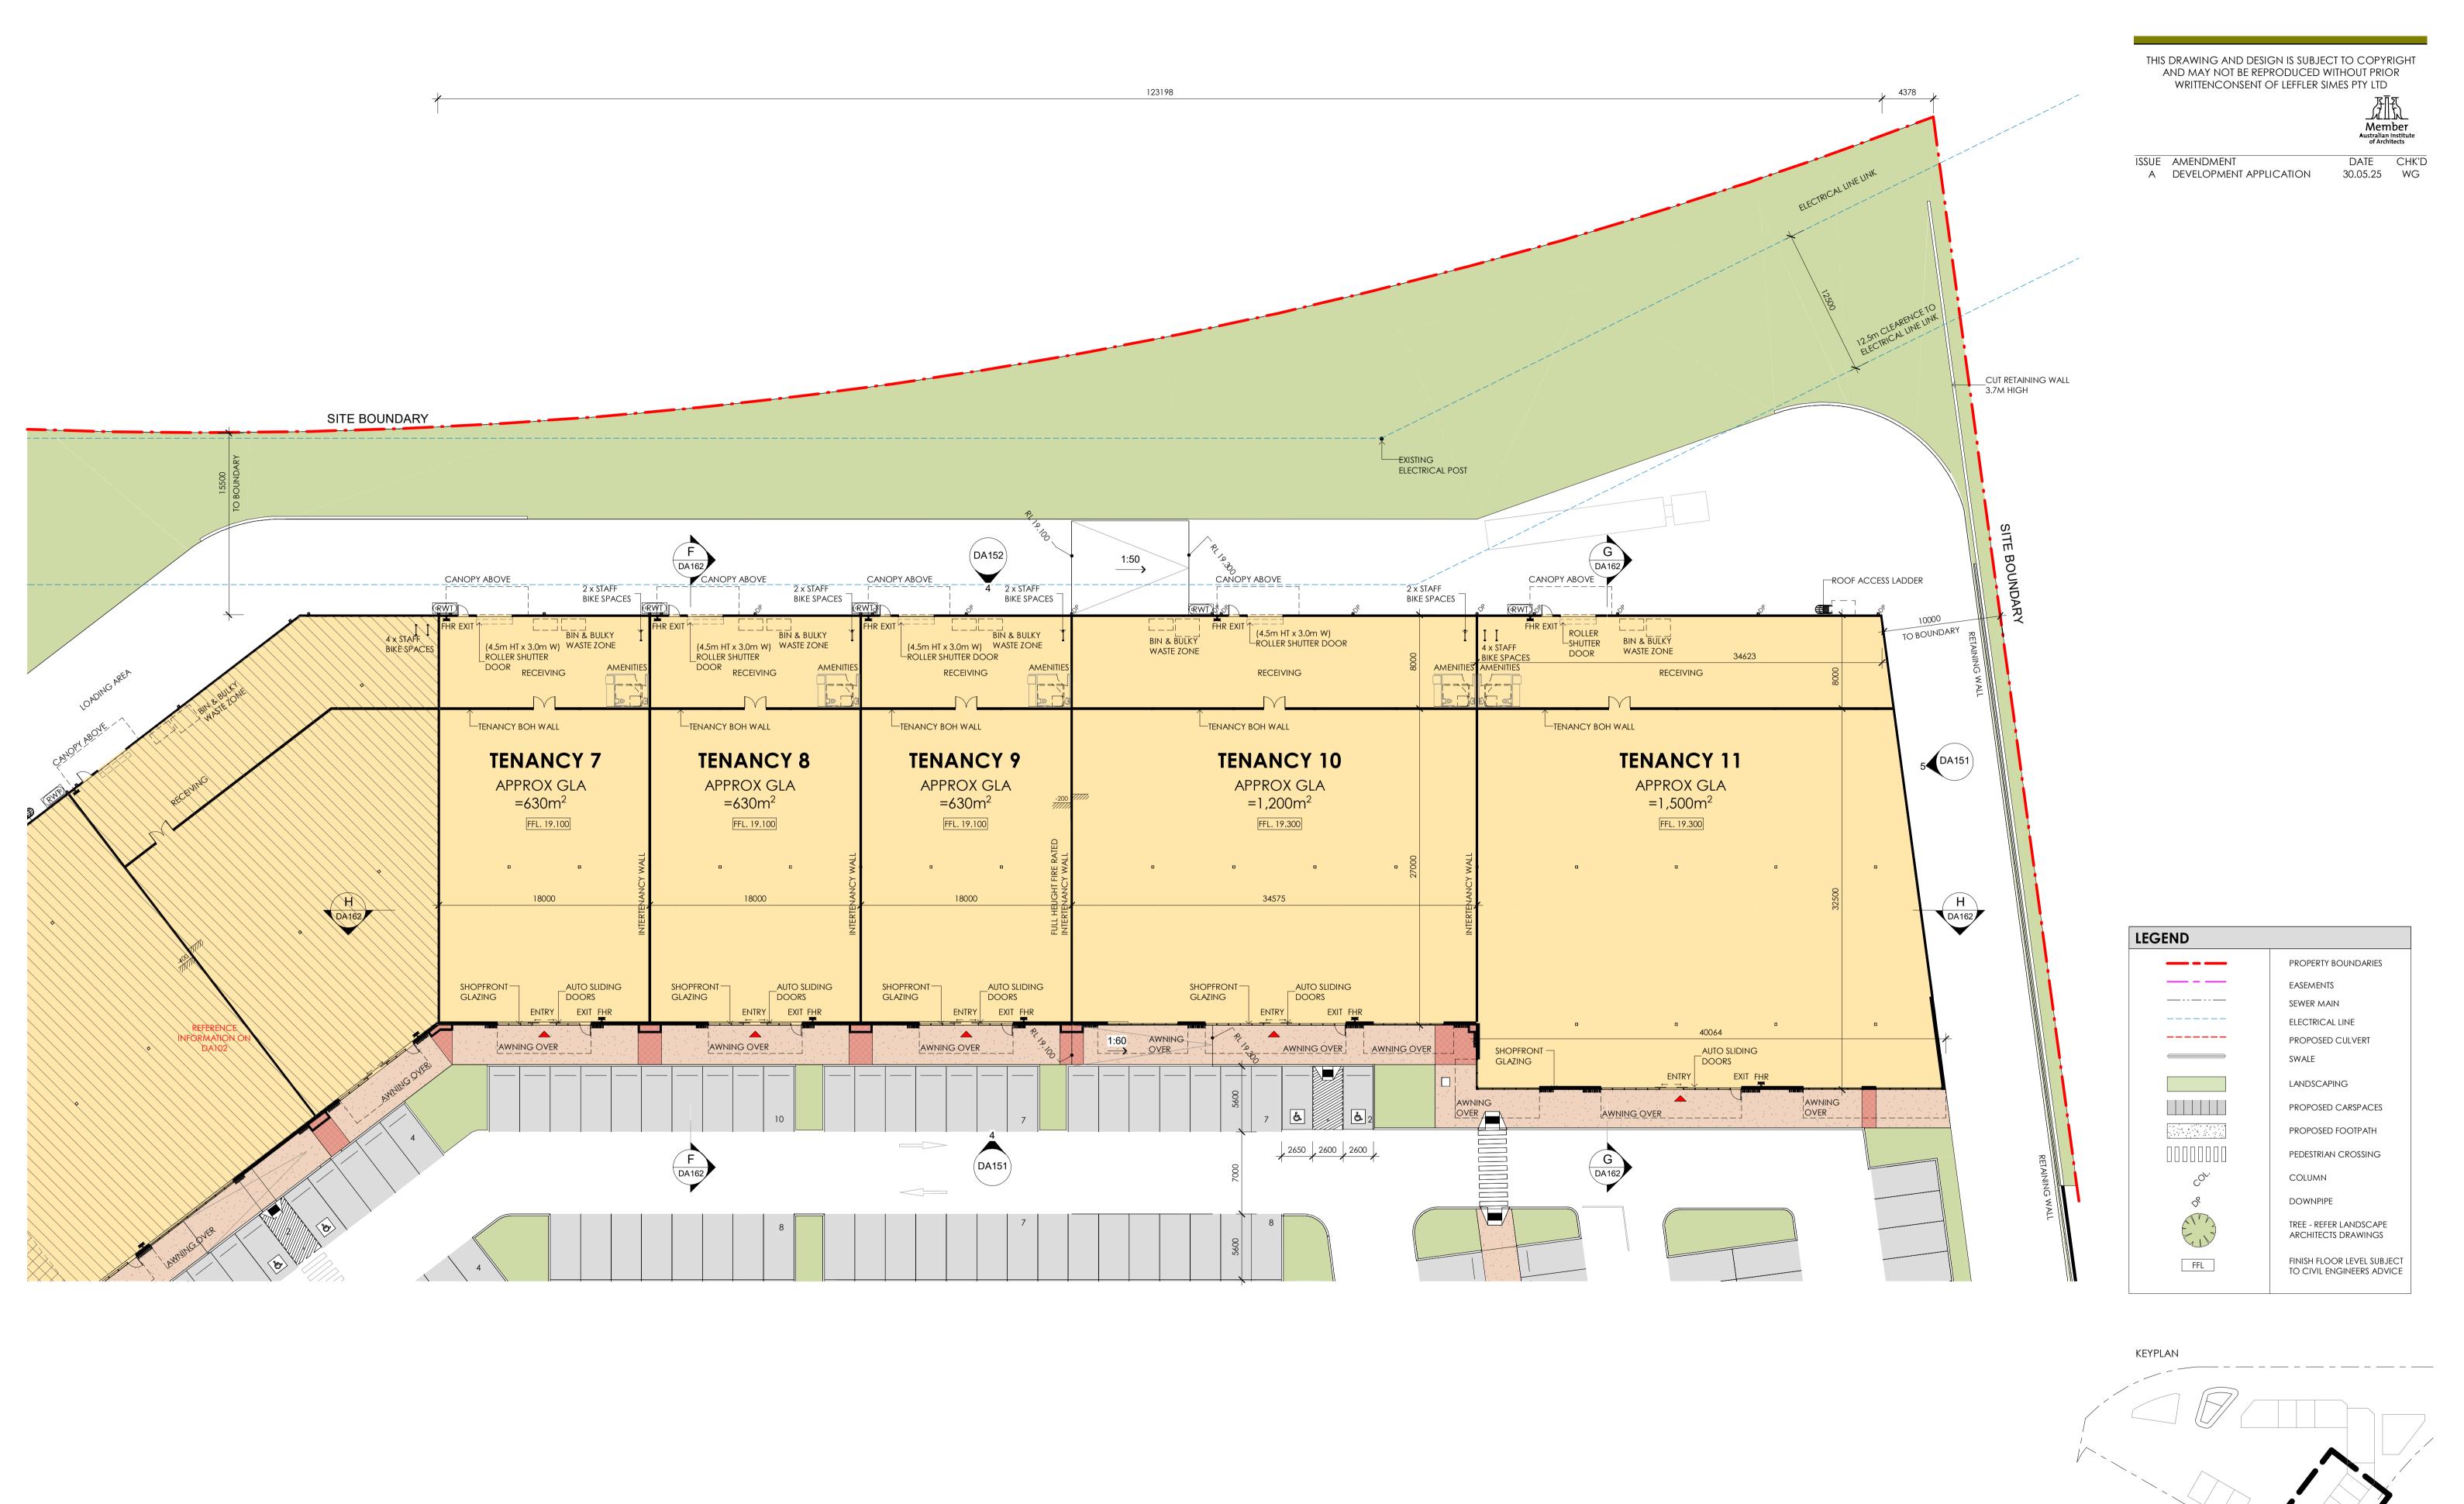

DEVELOPMENT APPLICATION

TENANCY 7-11 GROUND FLOOR PLAN

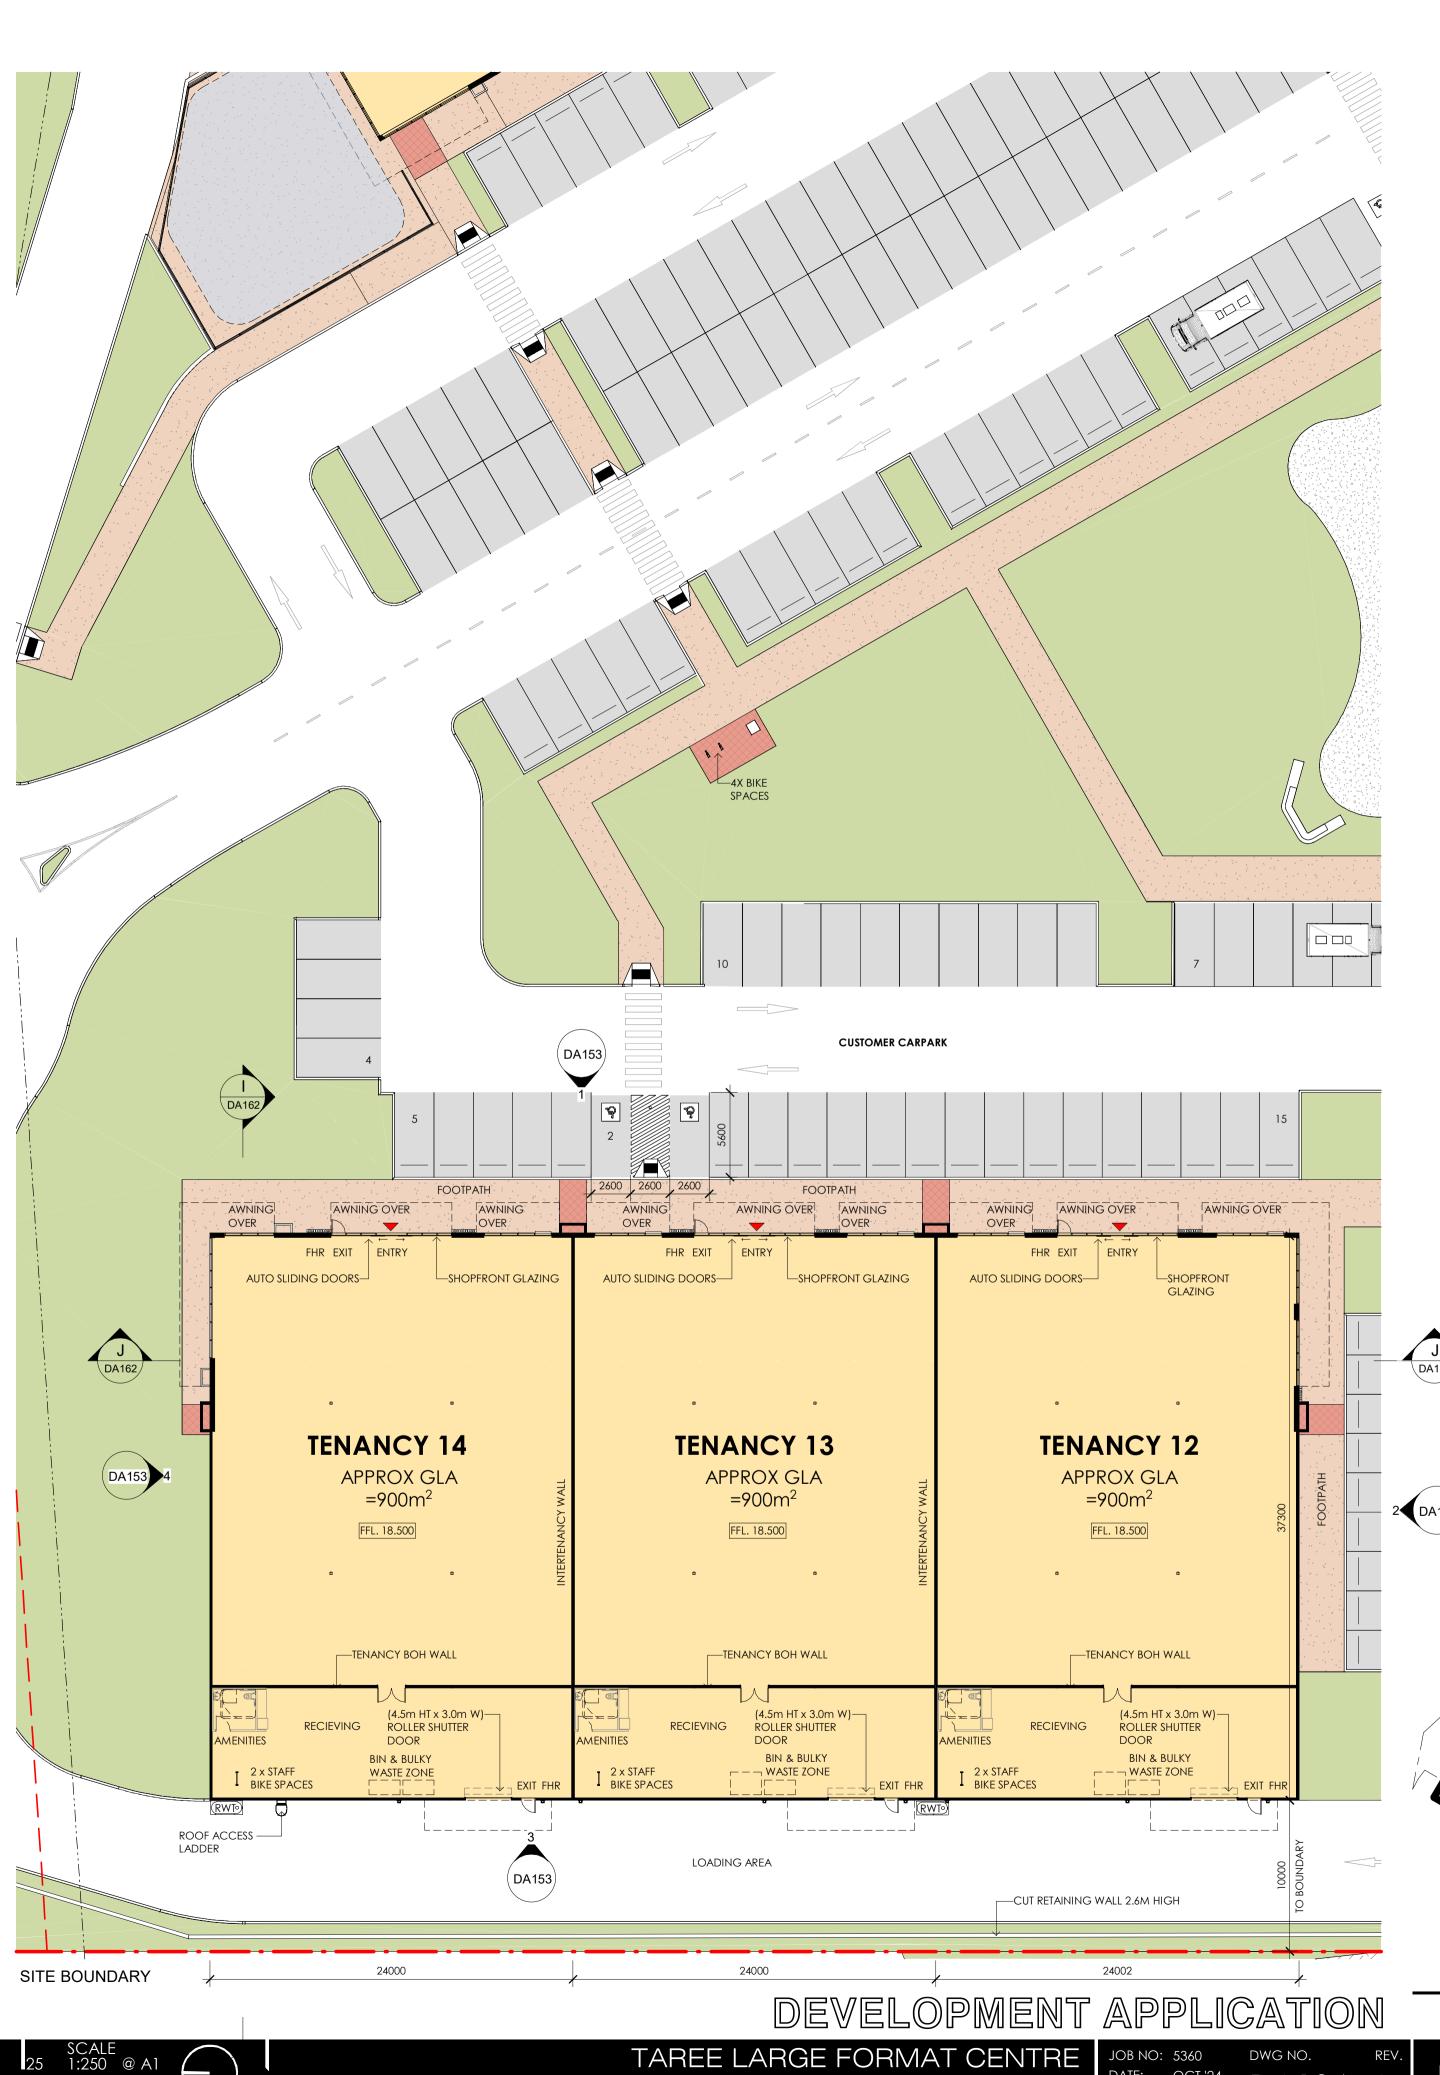

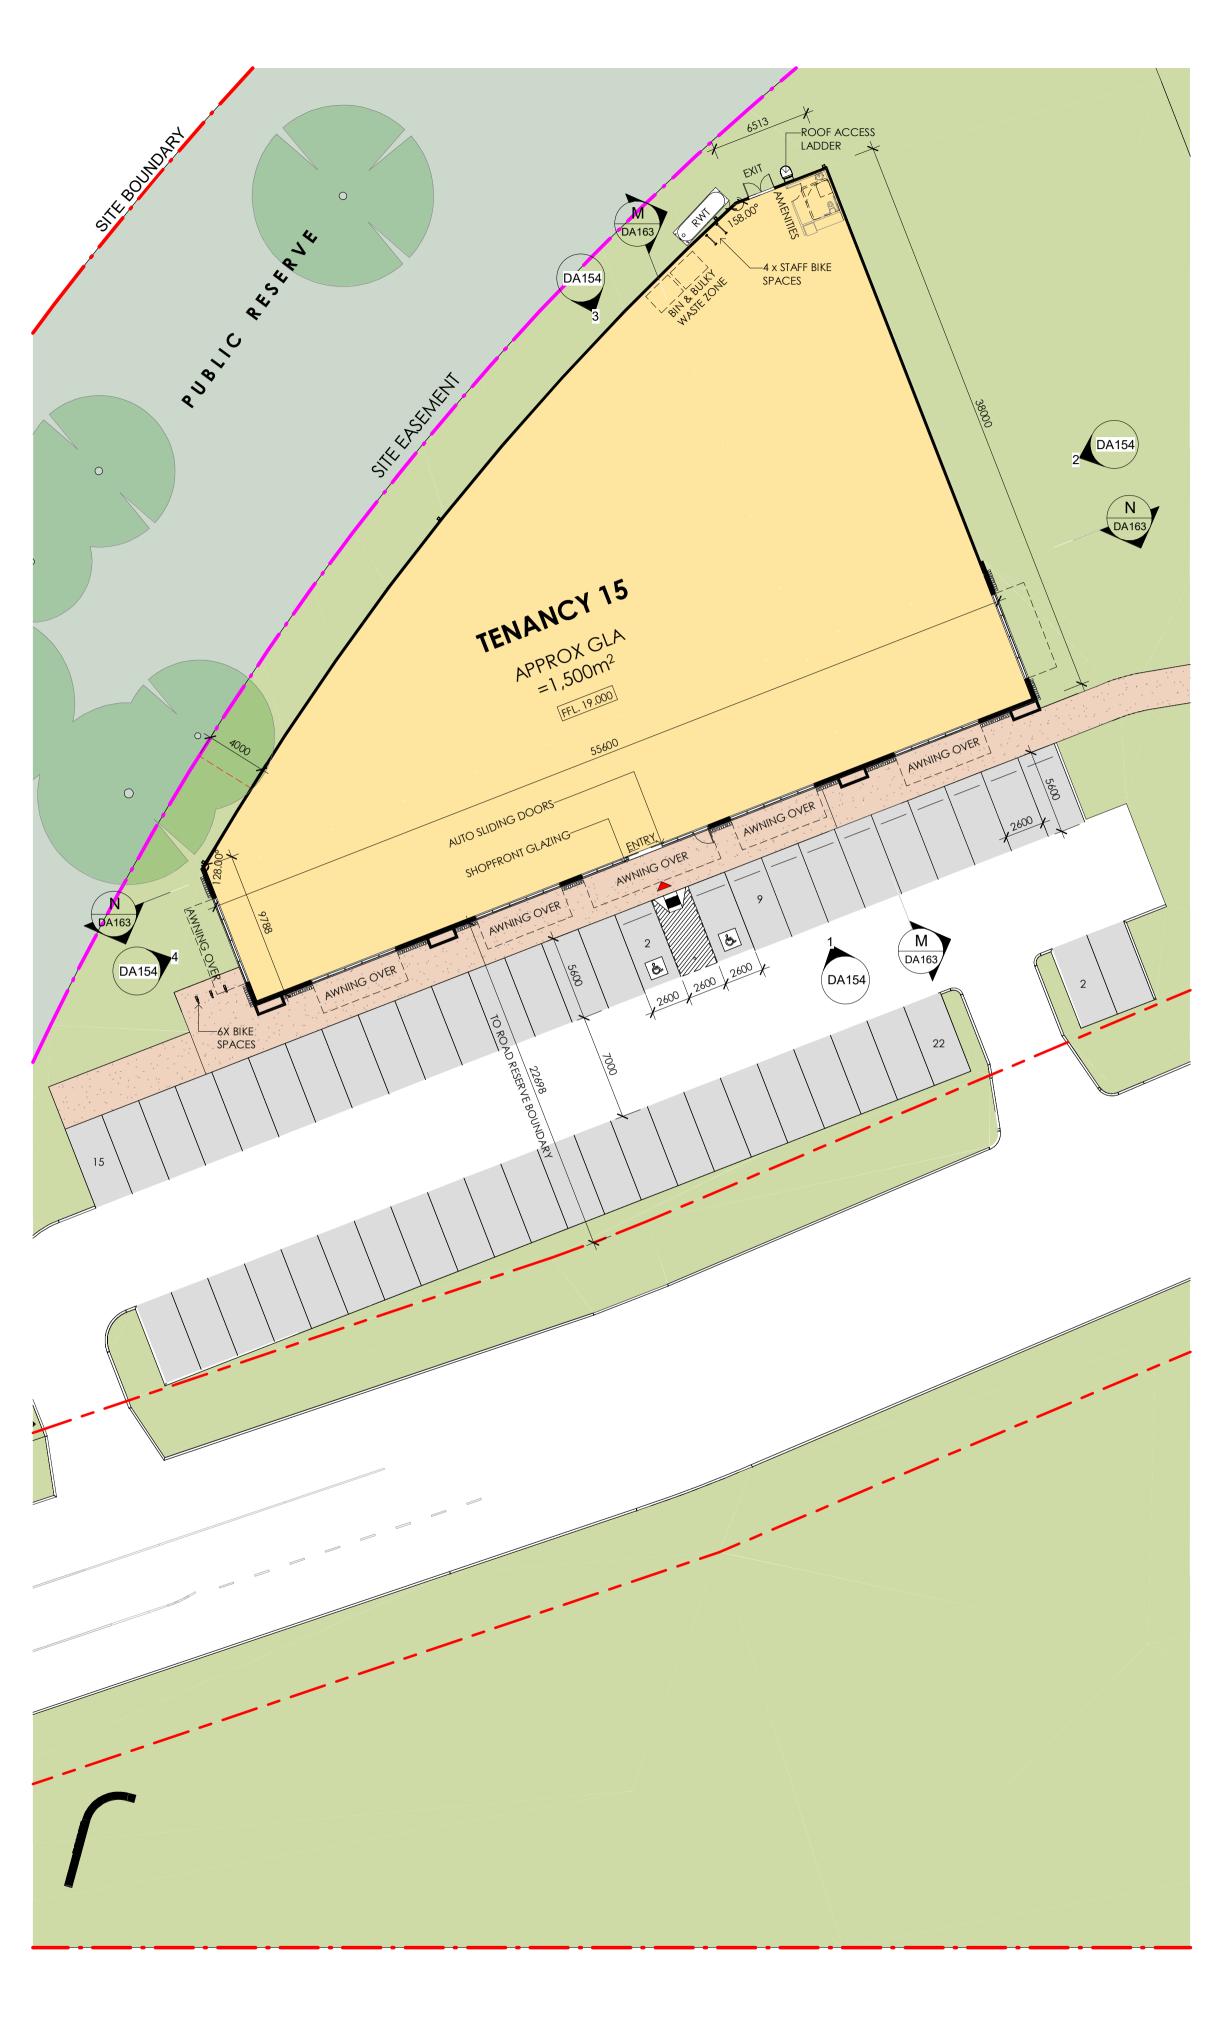

LEFFLER SIMES PTY LTD

WEB: www.lefflersimes.com.au


ABN 39 001 043 992


FLOOR PLAN

30.05.25 WG

PUBLIC RESERVE


SITE EASEMENT

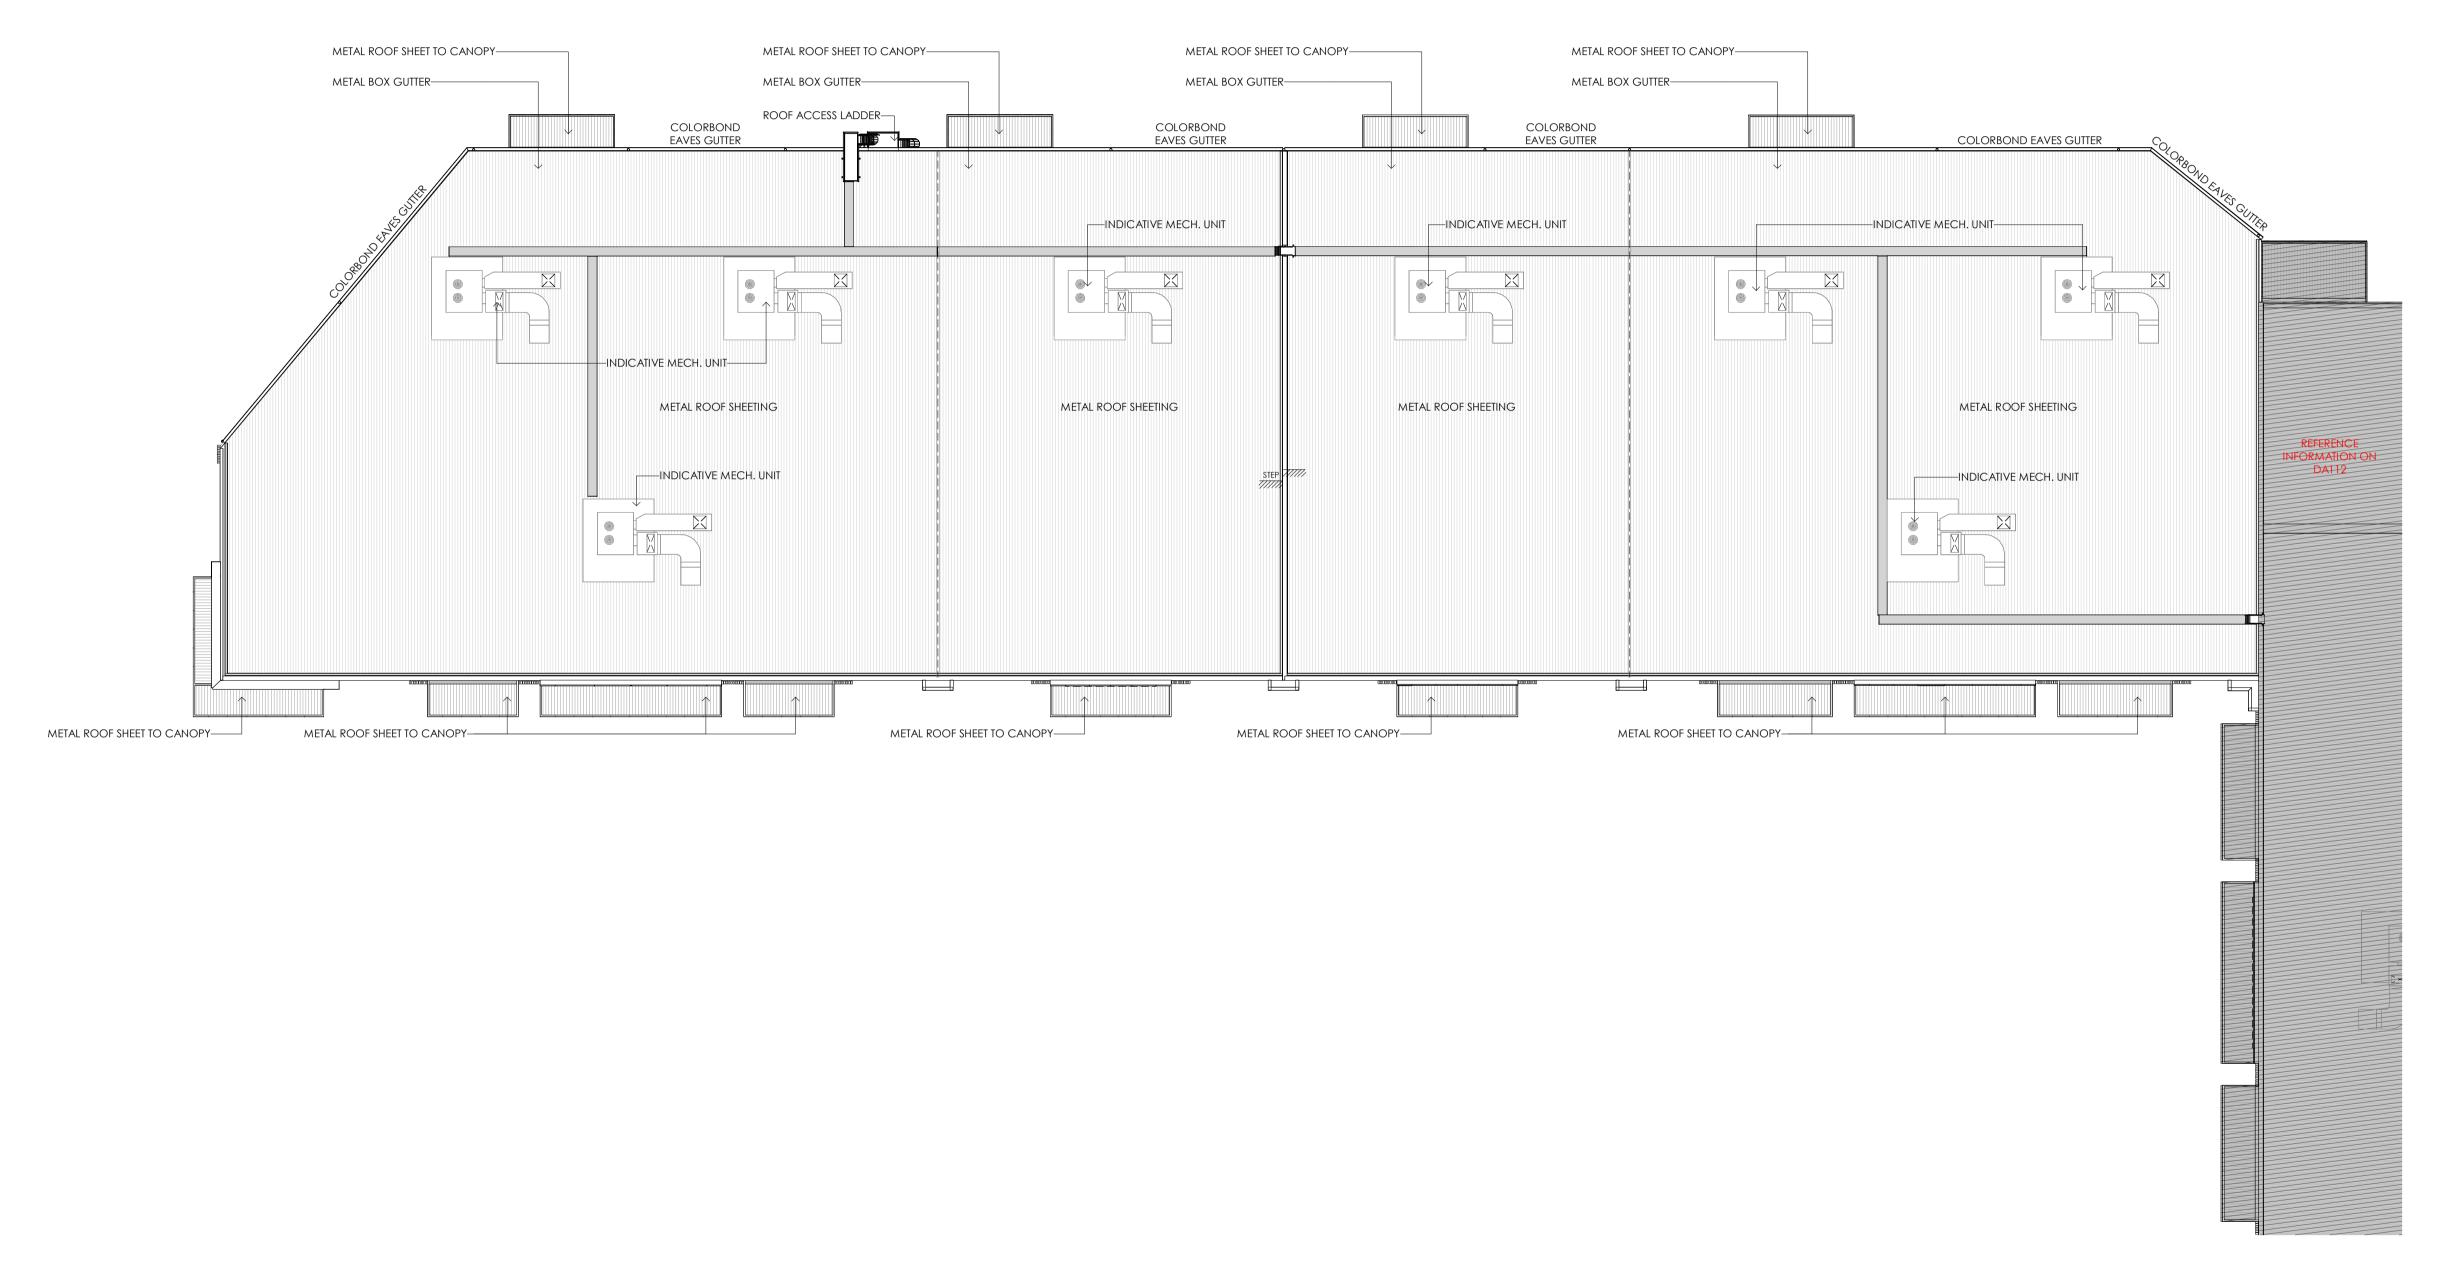

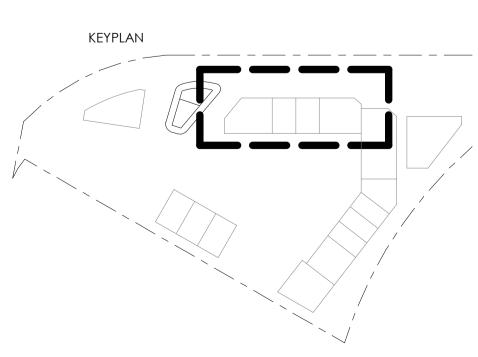

30.05.25 WG

ISSUE AMENDMENT A DEVELOPMENT APPLICATION

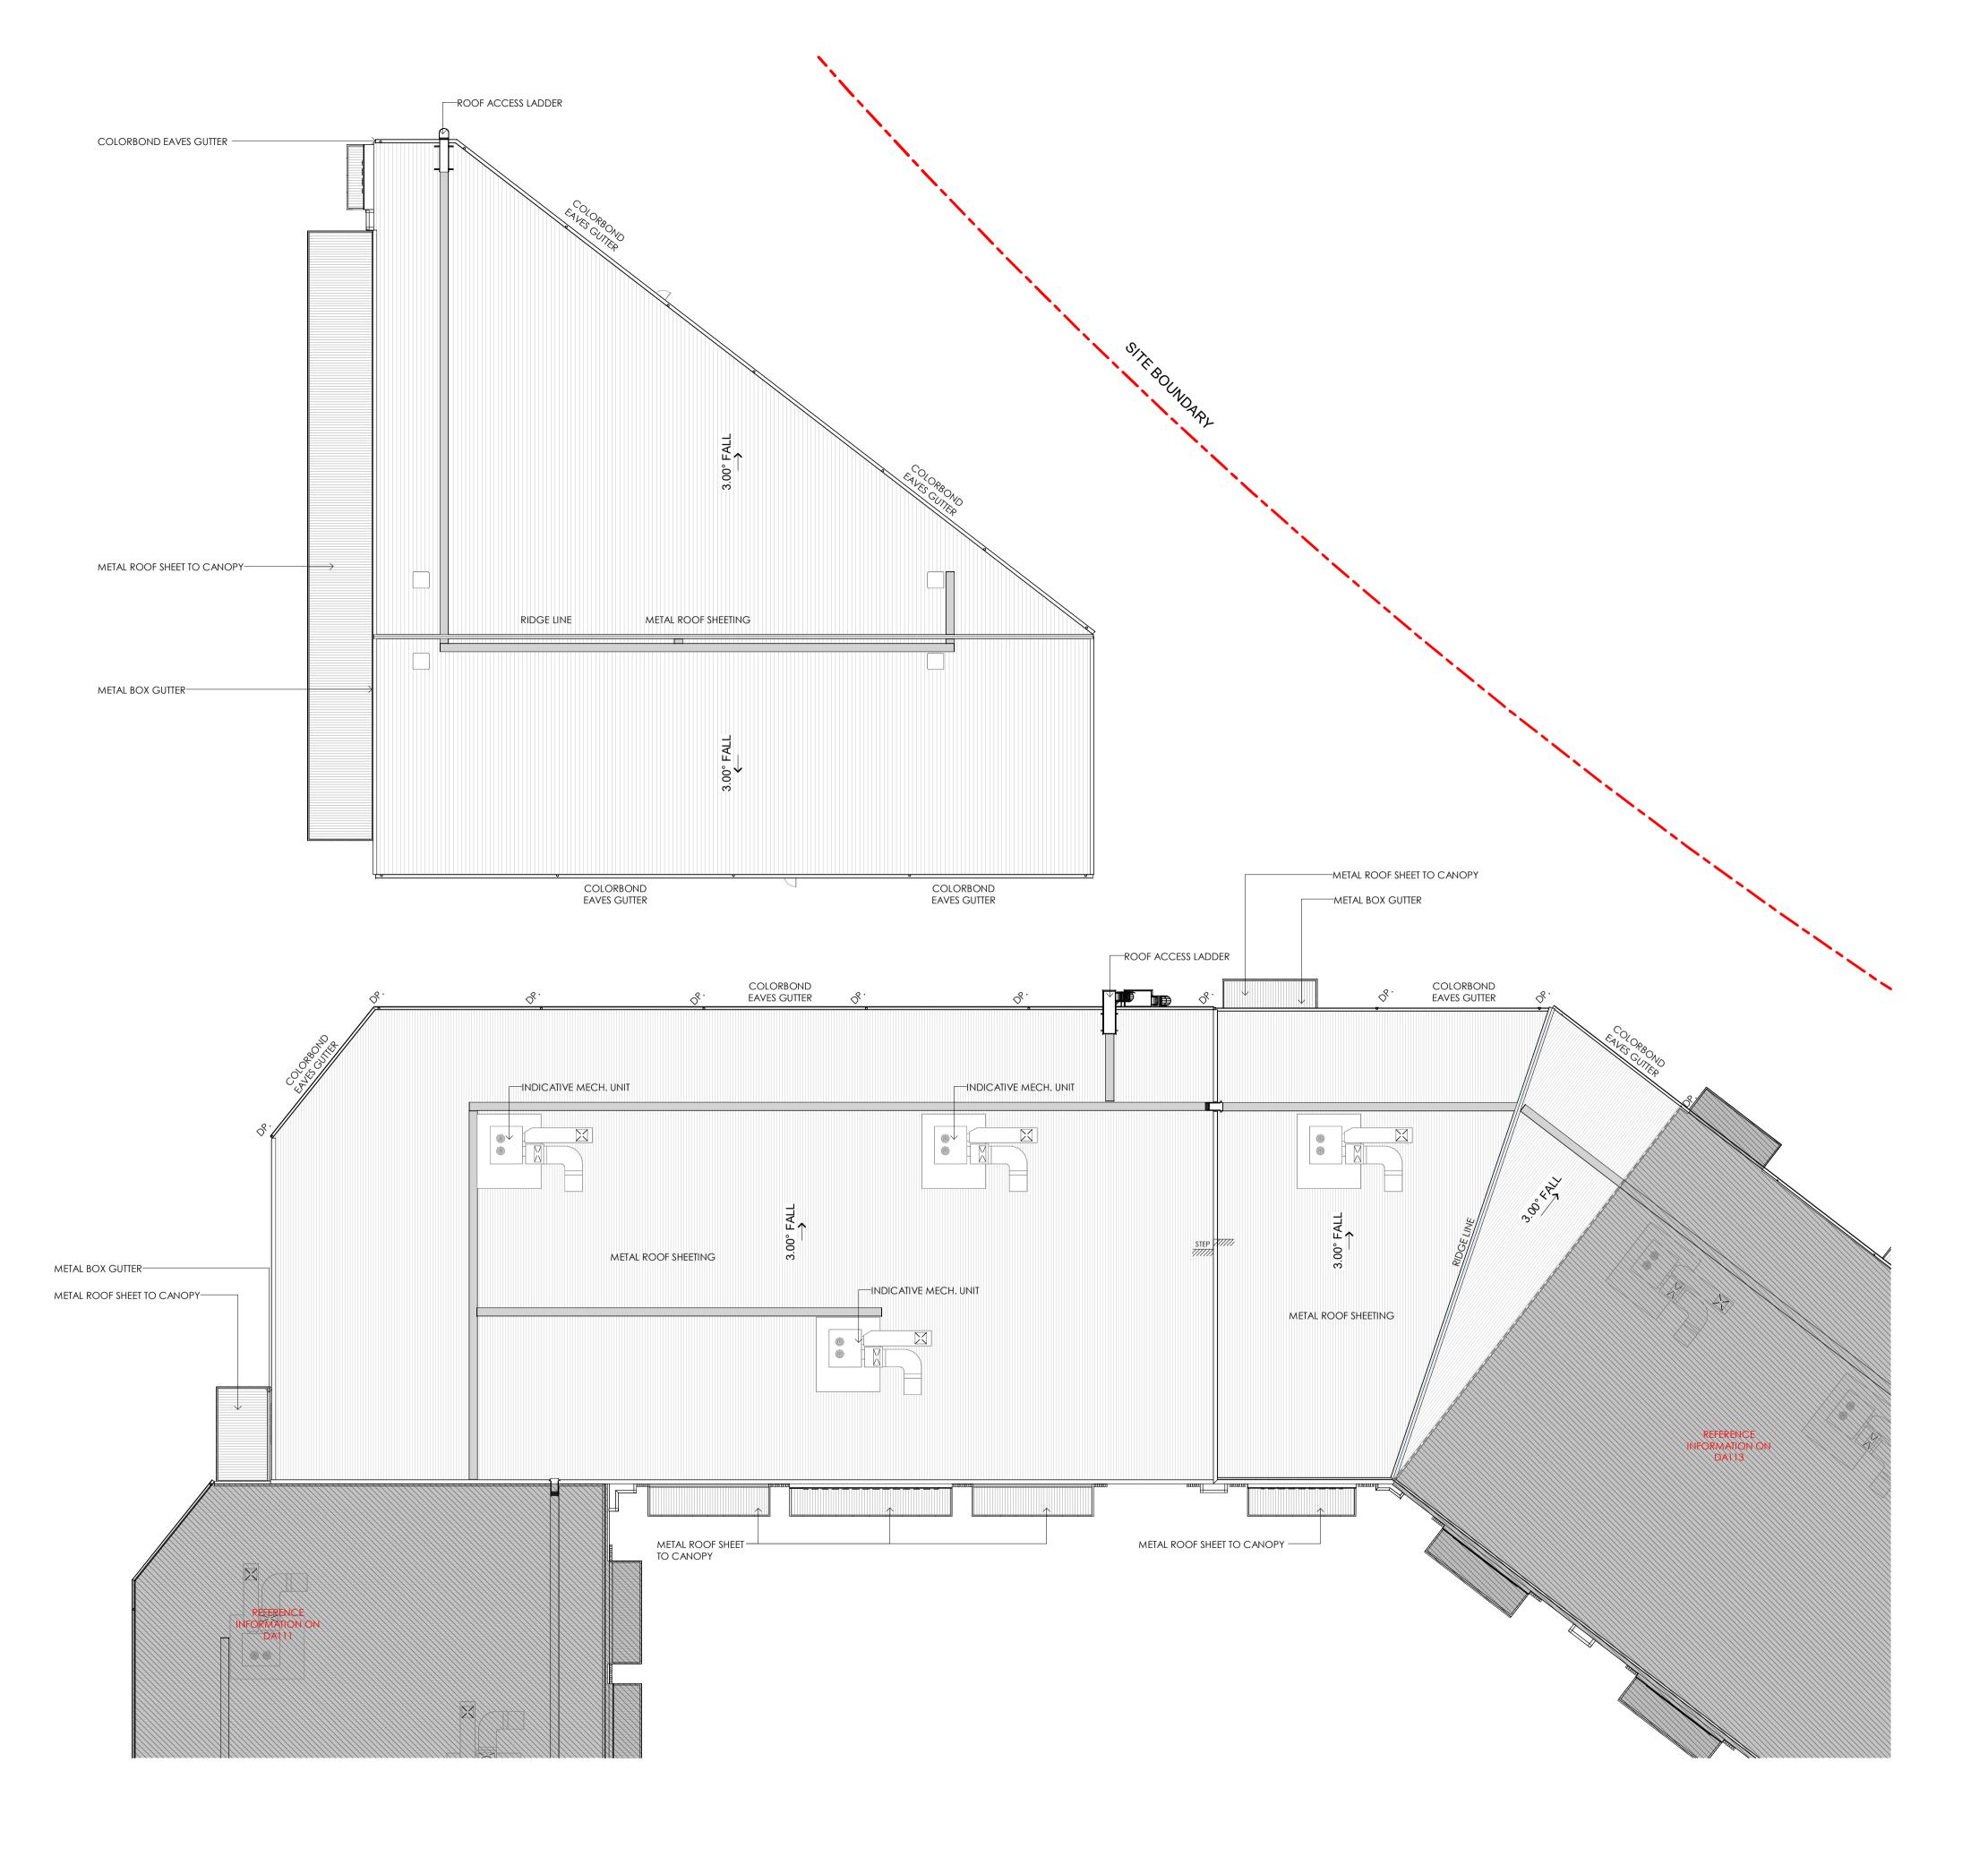

KEYPLAN

DEVELOPMENT APPLICATION


TENANCY 5-6, 16 ROOF PLAN


Member
Australian Institute
of Architects

ISSUE AMENDMENT

A DEVELOPMENT APPLICATION

30.05.25 WG

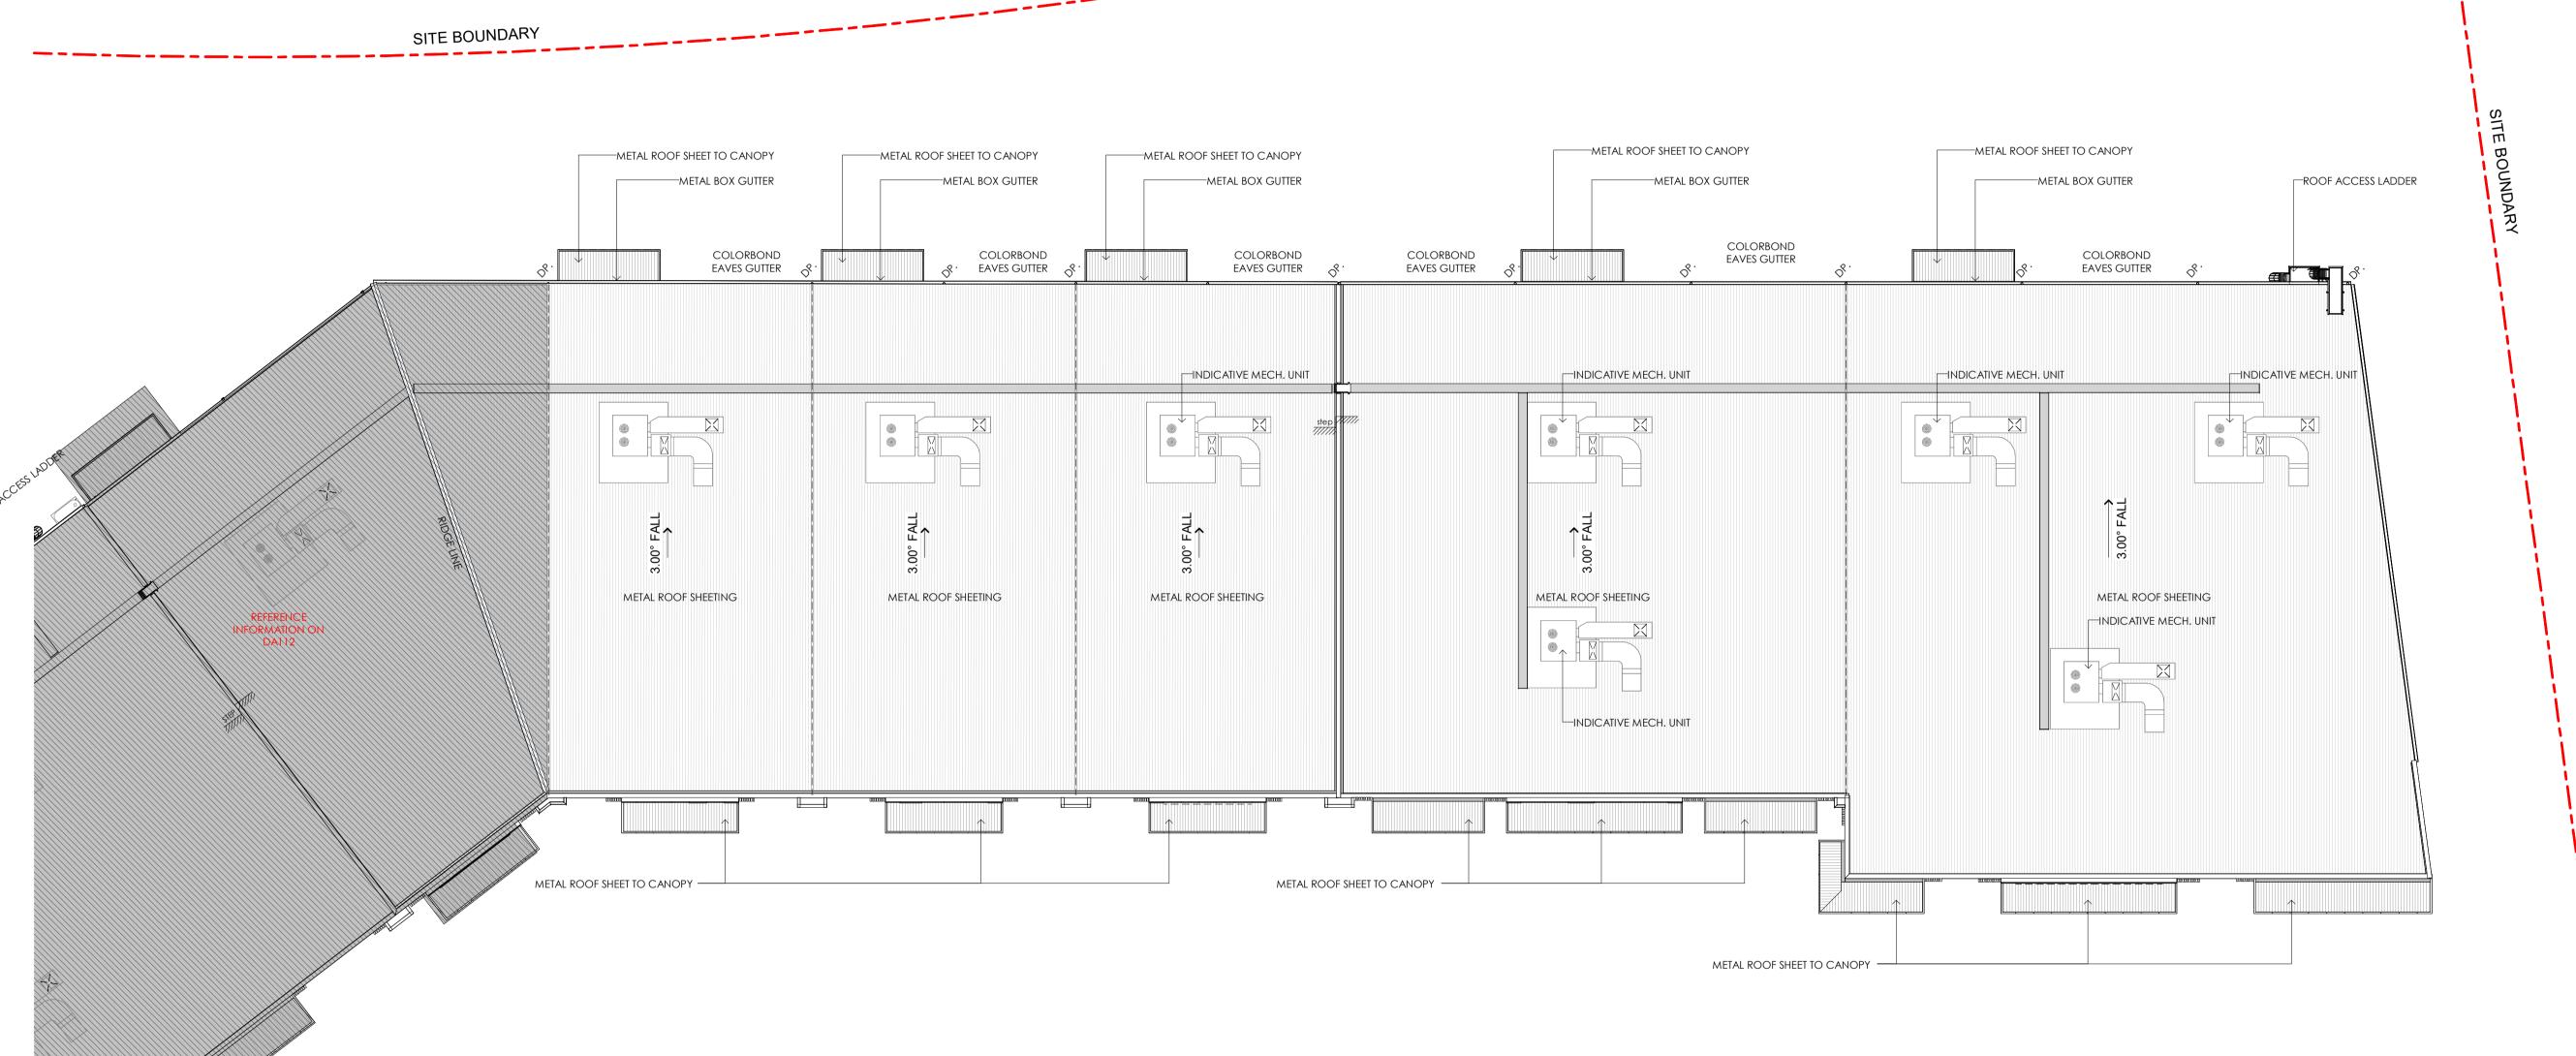

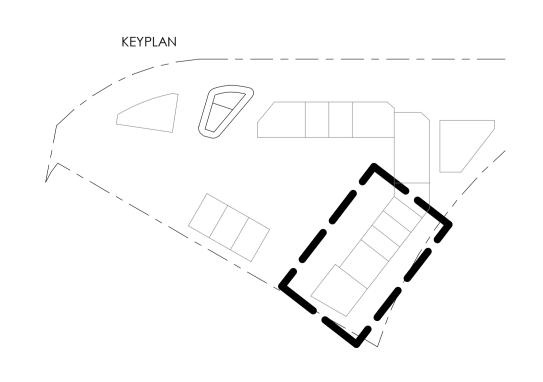

DEVELOPMENT APPLICATION


TENANCY 7-11 ROOF PLAN

DATE CHK'D 30.05.25 WG

ISSUE AMENDMENT
A DEVELOPMENT APPLICATION




SITE BOUNDARY

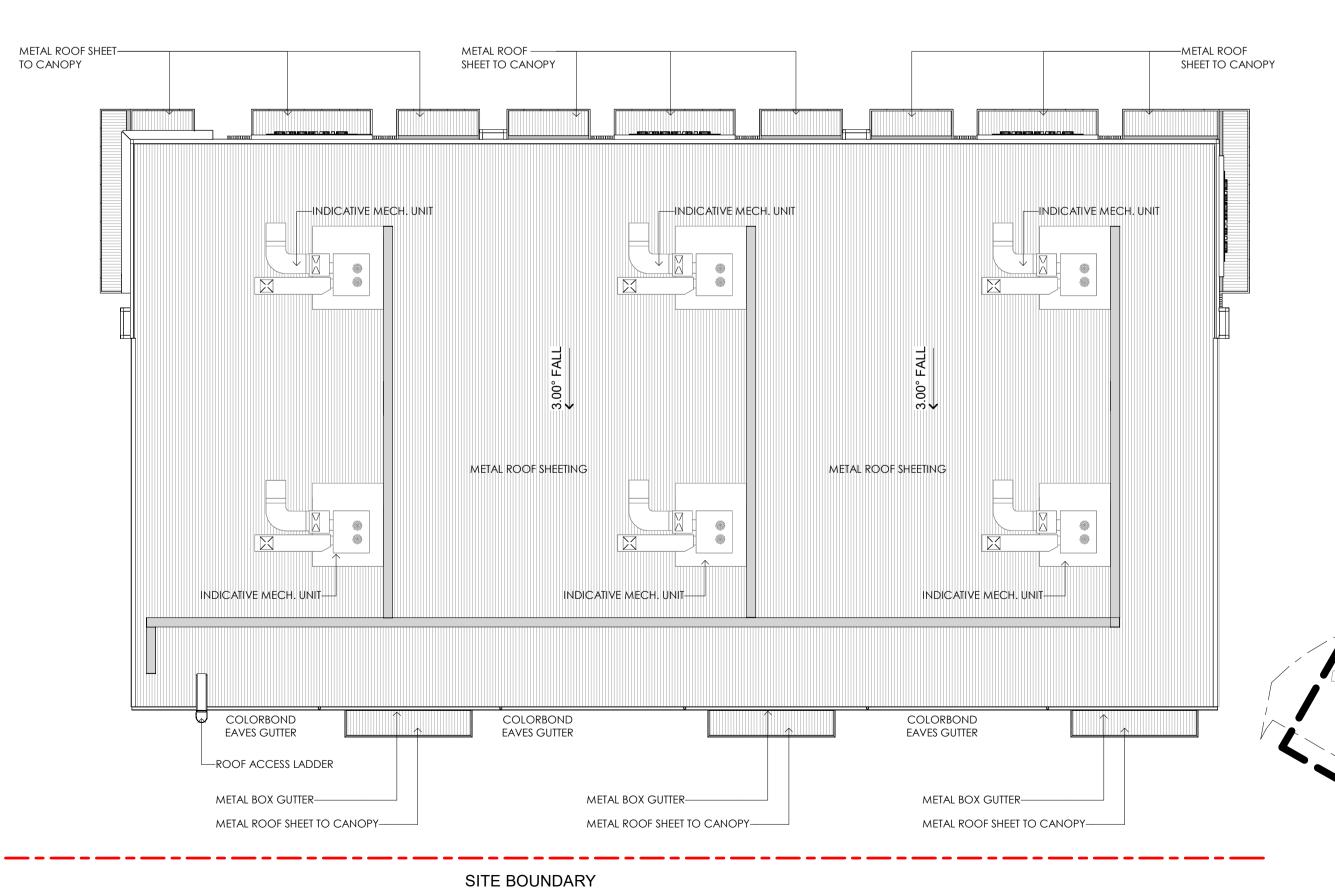

DEVELOPMENT APPLICATION

TENANCY 12-15 ROOF PLAN

THIS DRAWING AND DESIGN IS SUBJECT TO COPYRIGHT AND MAY NOT BE REPRODUCED WITHOUT PRIOR WRITTENCONSENT OF LEFFLER SIMES PTY LTD —ILLUMINATED SIGNAGE ZONE $5.0m(W) \times 2.5m(H)$ $10.0m(W) \times 3.5m(H)$ $6.0m(W) \times 3.5m(H)$ $6.0m(W) \times 3.5m(H)$ $10.0m(W) \times 3.5m(H)$ TOP OF PARAPET TOP OF PARAPET RL 28.600 RL 28.600 RL 28.400 RL 27.900 **ISSUE AMENDMENT** SIGNAGE SIGNAGE SIGNAGE A DEVELOPMENT APPLICATION SIGNAGE U/S OF AWNING U/S OF AWNING RL 22.000 GROUND FLOOR RL 18.400 **GROUND FLOOR** G E G | E || G | | E | D | A | B | F Α | E || A | A **EAST ELEVATION T1-T4** A100 Scale: 1:250 —ILLUMINATED SIGNAGE ZONE —ILLUMINATED SIGNAGE ZONE —ILLUMINATED SIGNAGE ZONE $10.0m(W) \times 3.5m(H)$ $6.0m(W) \times 3.5m(H)$ $5.0m(W) \times 2.5m(H)$ TOP OF PARAPET TOP OF PARAPET TOP OF PARAPET RL 29.300 RL 27.400 RL 27.000 SIGNAGE SIGNAGE SIGNAGE U/S OF AWNING U/S OF AWNING | | • | | RL 22.700 U/S OF AWNING RL 22.3<u>00</u> RL 21.800 **GROUND FLOOR** GROUND FLOOR **GROUND FLOOR** RL 18.700 RL 18.200 ADGE C | E | G | | F || A || E || G || H **NORTH ELEVATION T1 NORTH ELEVATION T5-T6** \ A100 A100 Scale: 1:250 Scale: 1:250 —ILLUMINATED SIGNAGE ZONE -- ILLUMINATED SIGNAGE ZONE —ILLUMINATED SIGNAGE ZONE —ILLUMINATED SIGNAGE ZONE —ILLUMINATED SIGNAGE ZONE $6.0m(W) \times 3.5m(H)$ $6.0m(W) \times 3.5m(H)$ $6.0m(W) \times 3.5m(H)$ $10.0m(W) \times 3.5m(H)$ $10.0m(W) \times 3.5m(H)$ RL 29.500 TOP OF PARAPET RL 28.050 RL 27.800 TOP OF PARAPET RL 27.800 RL 27.4<u>00</u> SIGNAGE SIGNAGE SIĞNAGE SIGNAGE SIGNAGE U/S OF AWNING RL 22.900 U/S OF AWNING **GROUND FLOOR** GROUND FLOOR RL 19.300 RL 19.100 H C A E G F C A E G F A E G C E F A E G **NORTH EAST ELEVATION T7-T11** A100 Scale: 1 : 250 RL 27.800

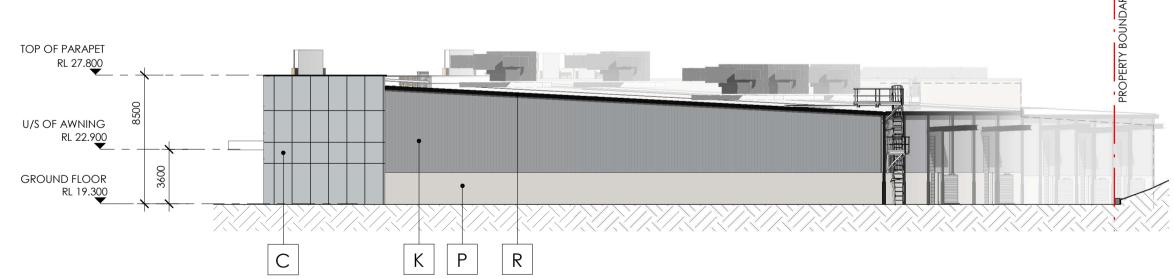











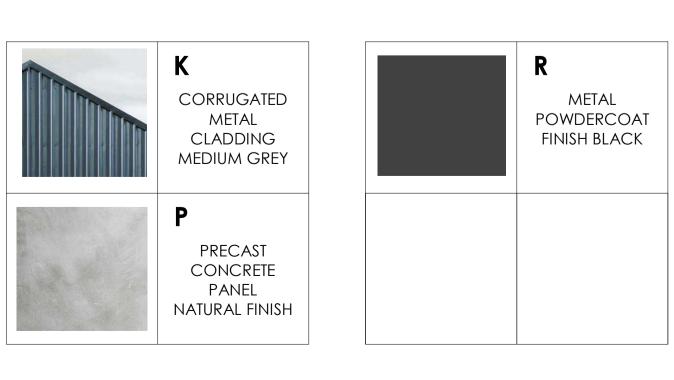

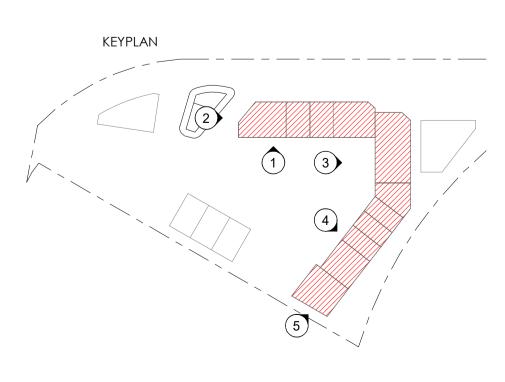

Member

DATE CHK'D

30.05.25 WG


DEVELOPMENT APPLICATION

ELEVATIONS - SHEET 1

Member
Australian Institute
of Architects

ISSUE AMENDMENT A DEVELOPMENT APPLICATION


30.05.25 WG

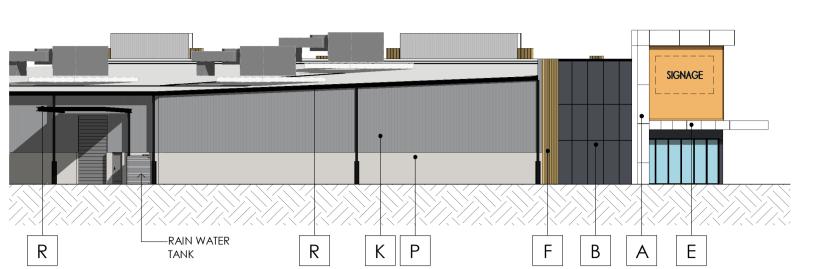

R K P R

–(4.5m HT x 3.0m W) ROLLER SHUTTER



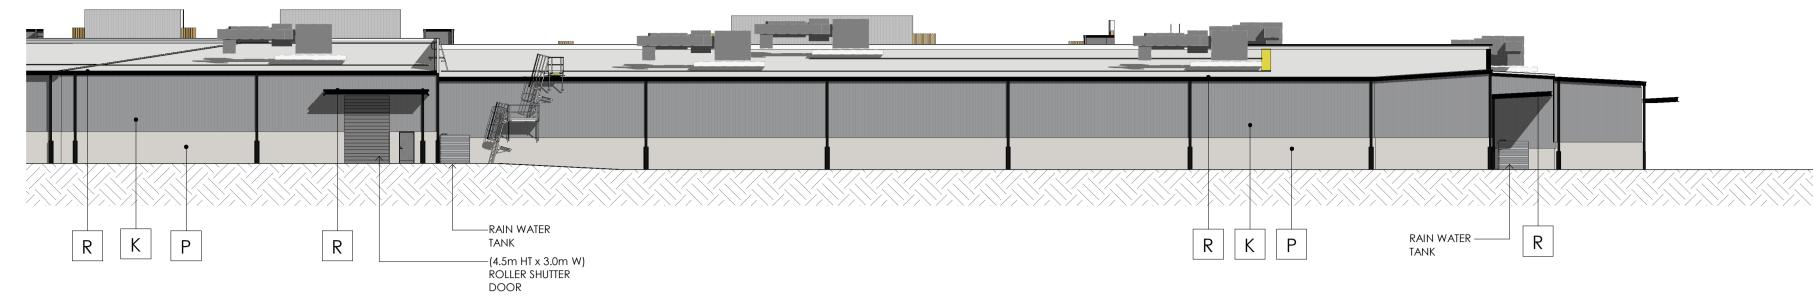

SOUTH ELEVATION T4-5 A100 Scale: 1:250

(4.5m HT x 3.0m W)——— ROLLER SHUTTER


DOOR

---RAIN WATER

TANK

EAST ELEVATION T1-4

Scale: 1:250

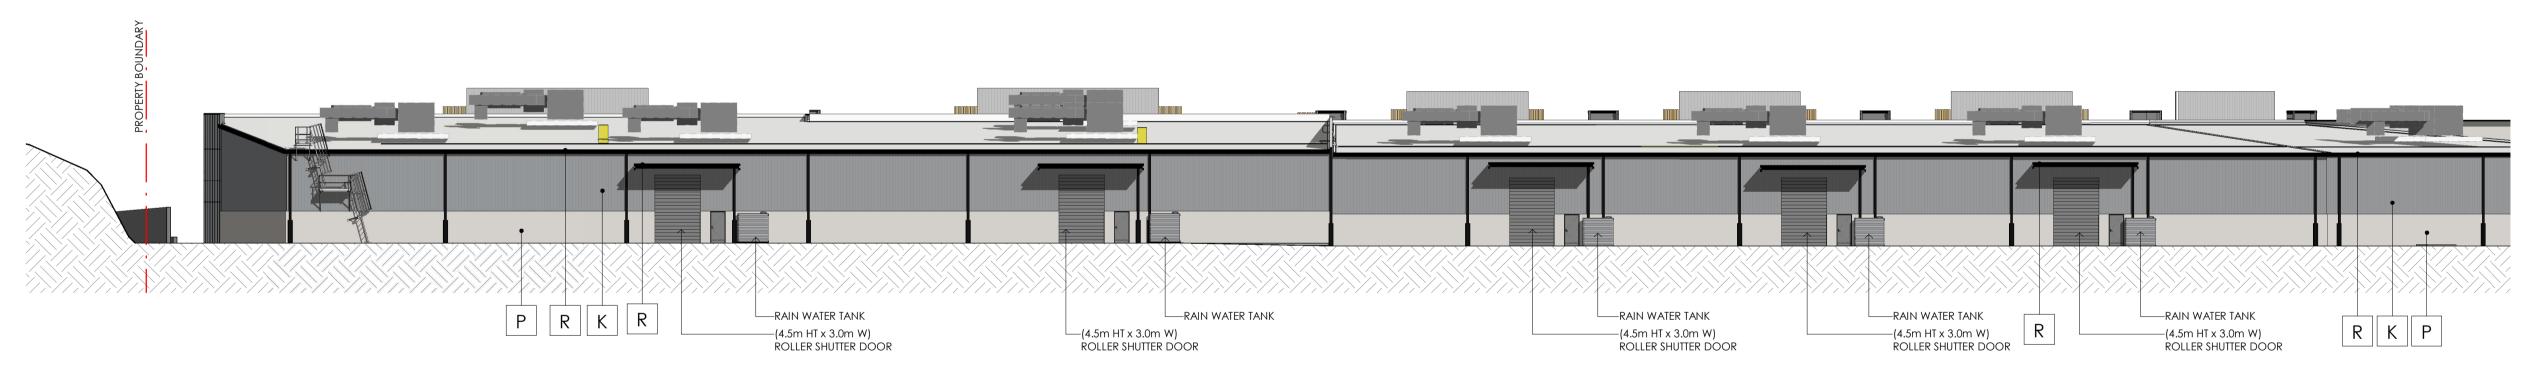

(4.5m HT x 3.0m W)——— ROLLER SHUTTER


DOOR


---RAIN WATER


| R || K || P

SOUTH WEST ELEVATION T5-10


Scale: 1 : 250

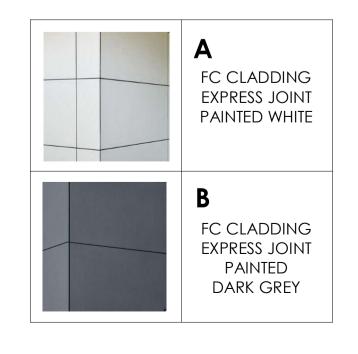

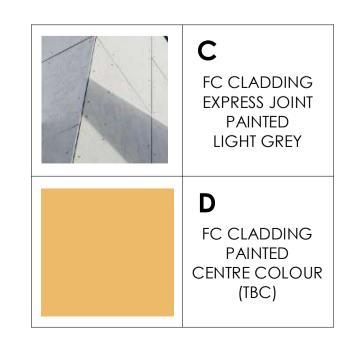

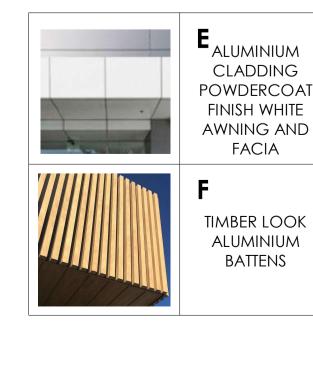




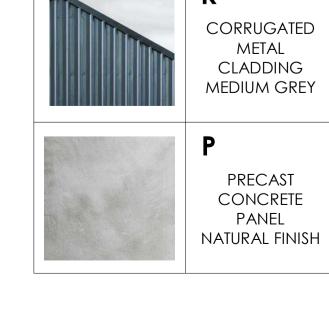

-RAIN WATER

-(4.5m HT x 3.0m W) ROLLER SHUTTER DOOR


TANK

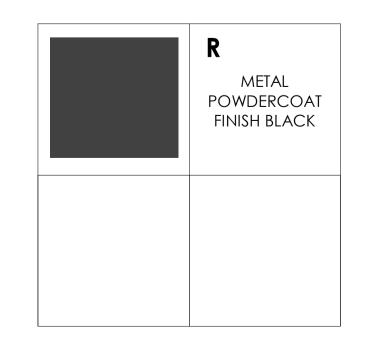


(4.5m HT x 3.0m W)——— ROLLER SHUTTER


DOOR

---RAIN WATER

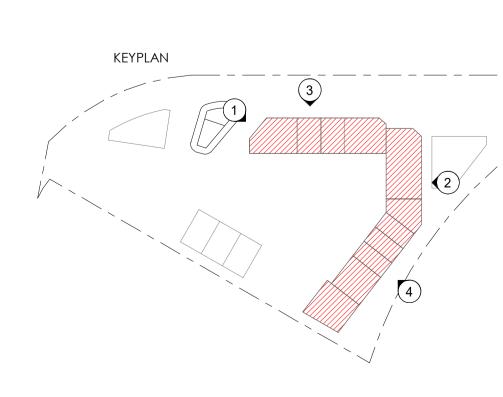


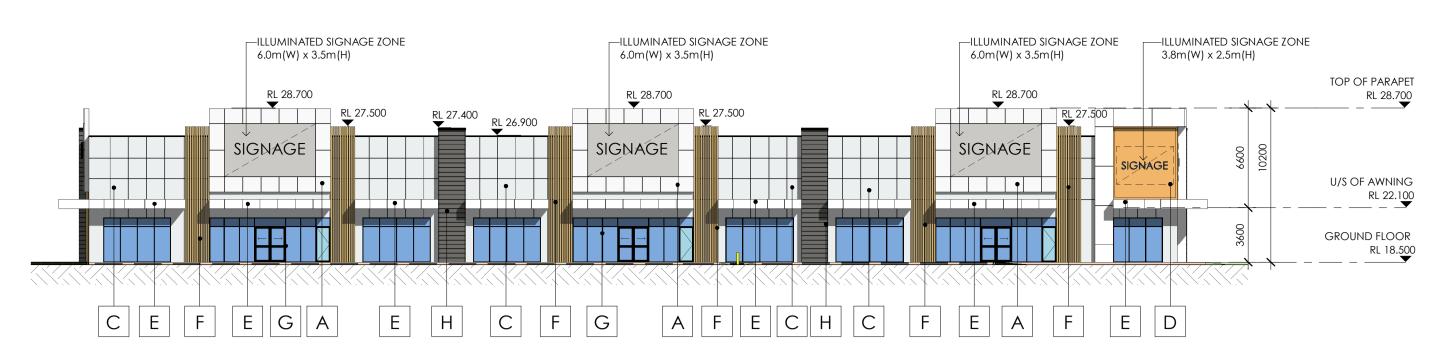


**SOUTH EAST ELEVATION T12-14 ** A100 ∕ Scale: 1 : 250

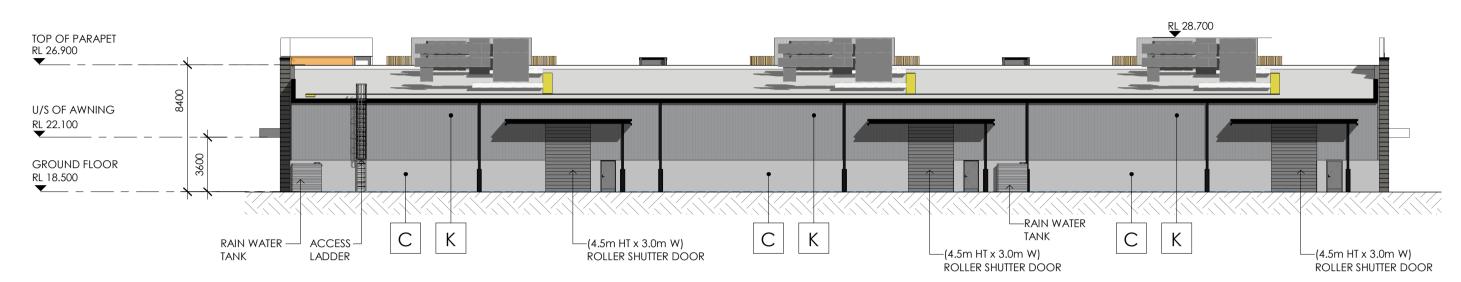


NORTH WEST ELEVATION T12-14 \ A100 / Scale: 1:250

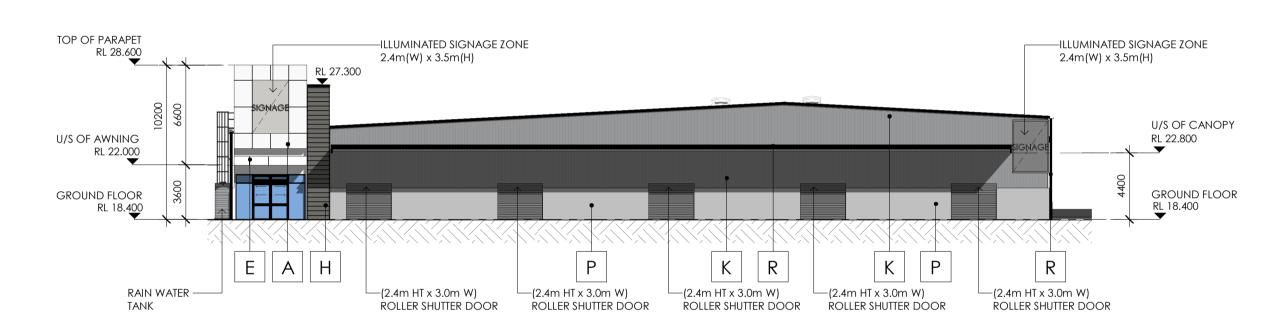


EAST ELEVATION T16 Scale: 1:250

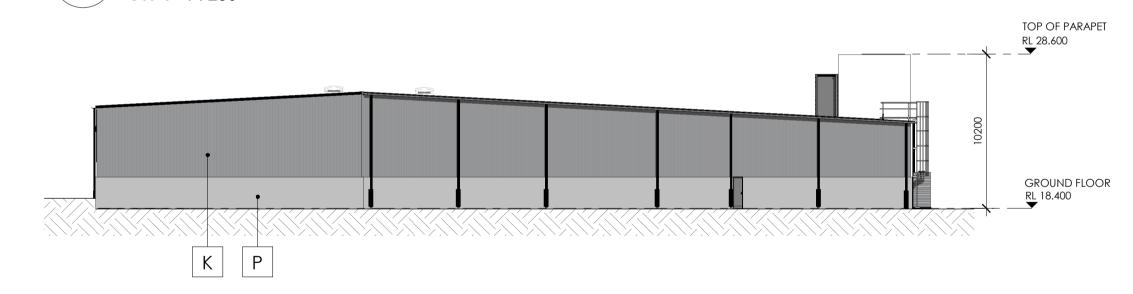

WEST ELEVATION T16 A100 Scale: 1 : 250

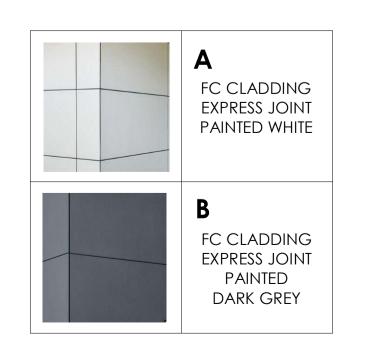

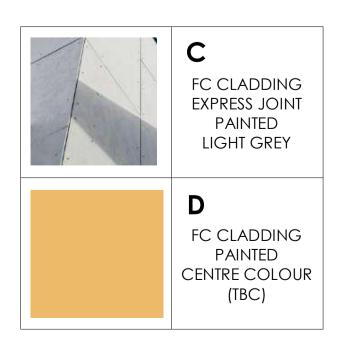








U/S OF CANOPY

GROUND FLOOR RL 18.500

RL 23.000

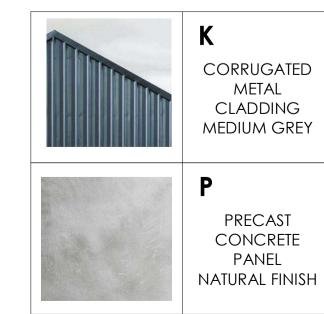

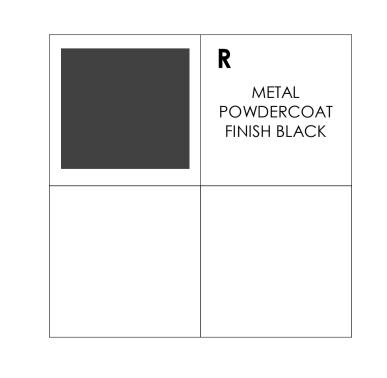

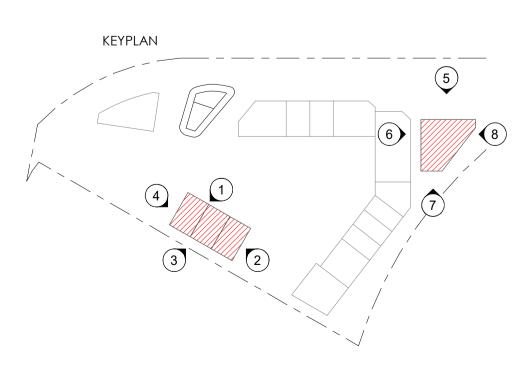

THIS DRAWING AND DESIGN IS SUBJECT TO COPYRIGHT

AND MAY NOT BE REPRODUCED WITHOUT PRIOR

WRITTENCONSENT OF LEFFLER SIMES PTY LTD

ISSUE AMENDMENT

A DEVELOPMENT APPLICATION

Member

DATE CHK'D

30.05.25 WG

SOUTH WEST ELEVATION T12-14 \ A100 ∫ Scale: 1:250

С

—ILLUMINATED SIGNAGE ZONE

TOP OF PARAPET

U/S OF AWNING


GROUND FLOOR RL 18.500

RL 28.700


RL 22.100

6.0m(W) x 3.5m(H)

| H | F | G | E | B

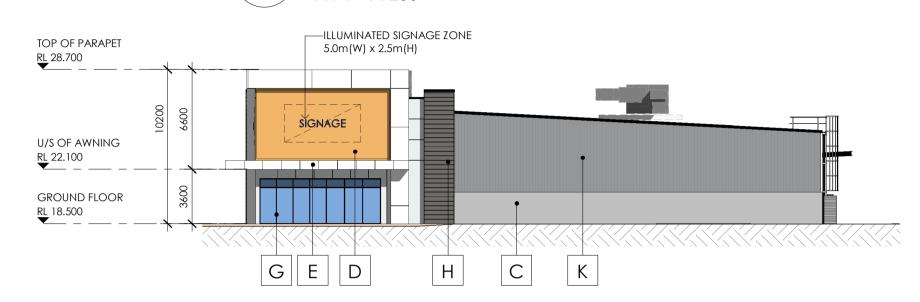

NORTH EAST ELEVATION T12-14 ∖ A100 ∫ Scale: 1:250

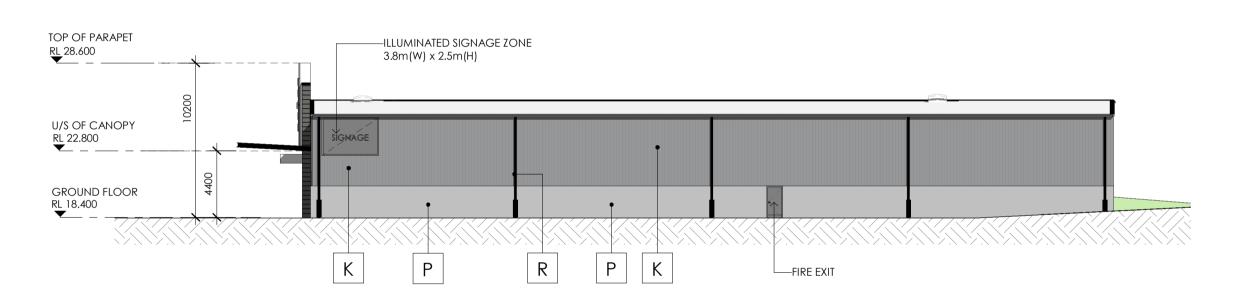

NORTH ELEVATION T16 Scale: 1:250




SOUTH ELEVATION T16 A100 Scale: 1 : 250


ISSUE AMENDMENT

A DEVELOPMENT APPLICATION


30.05.25 WG

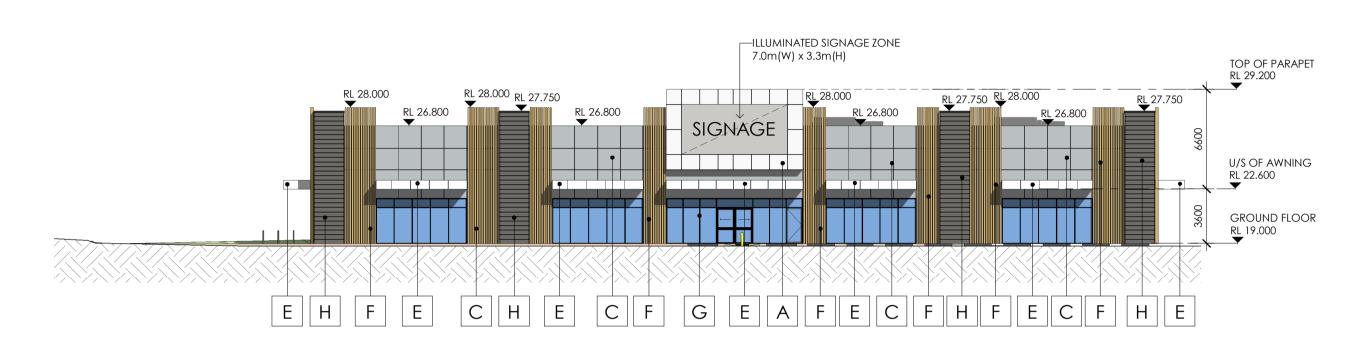


WEST ELEVATION T15 A100 / Scale: 1:250

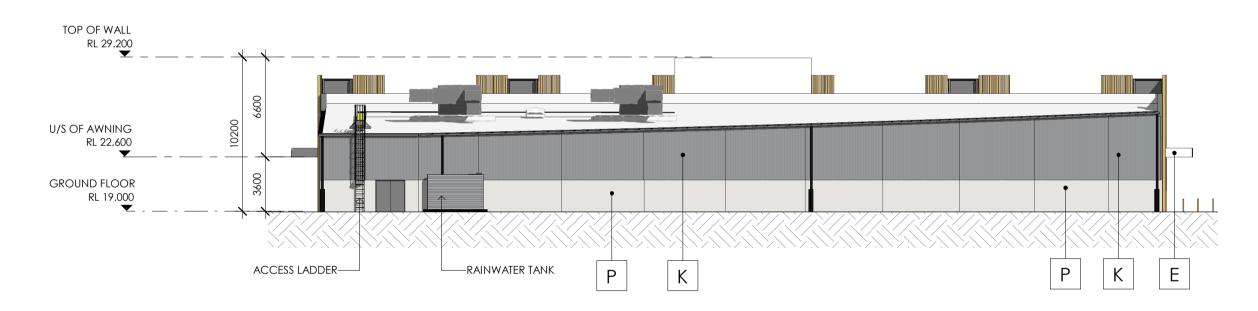


EAST ELEVATION T15 A100 Scale: 1 : 250

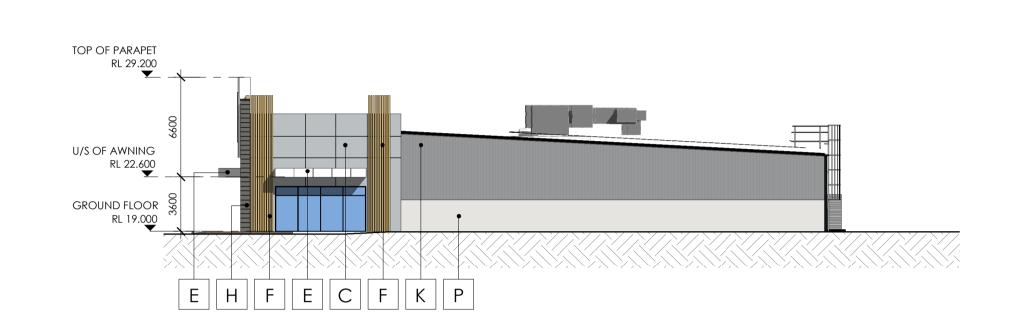



SOUTH ELEVATION T15 A100 Scale: 1:250

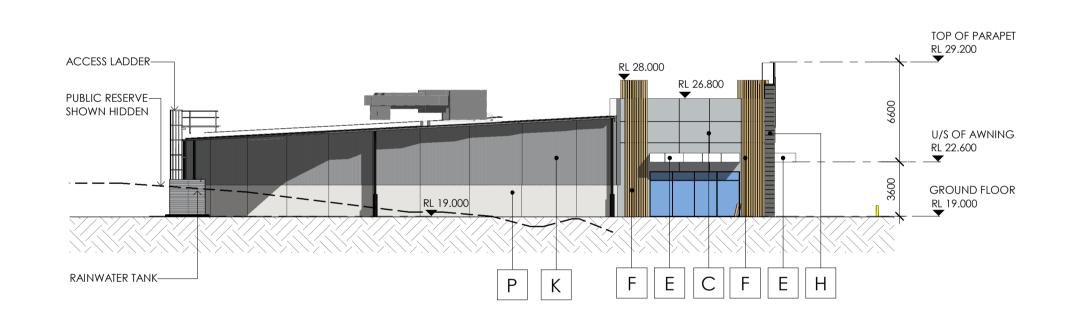


NORTH ELEVATION T15 A100

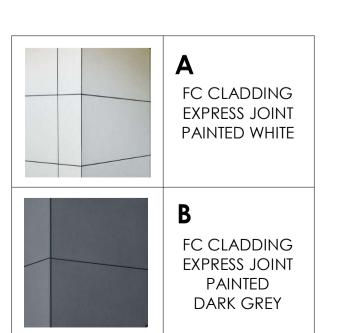


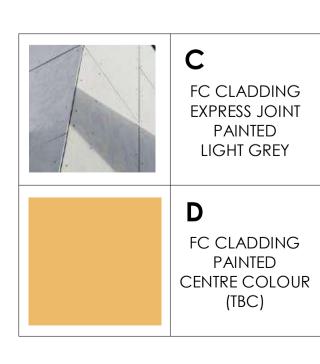


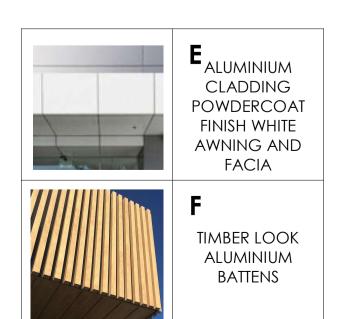




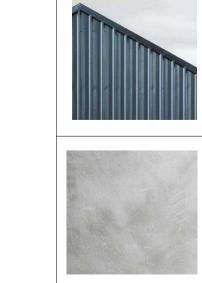


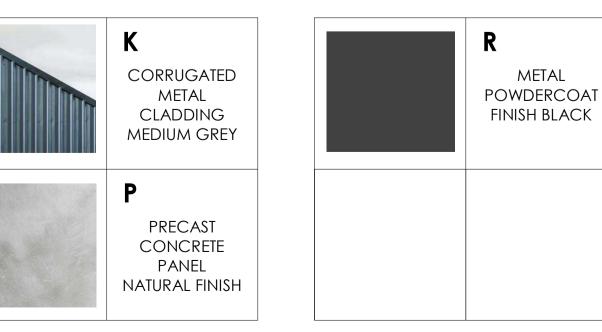

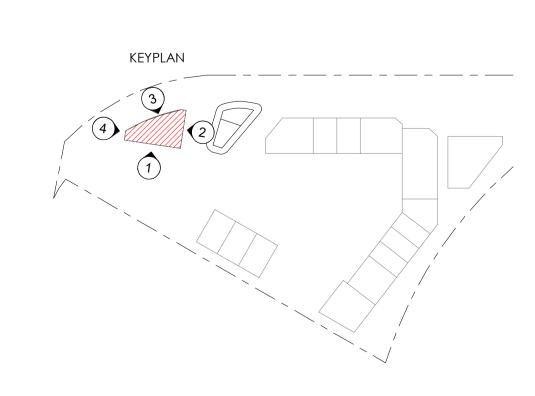

ISSUE AMENDMENT
A DEVELOPMENT APPLICATION DATE CHK'D 30.05.25 WG

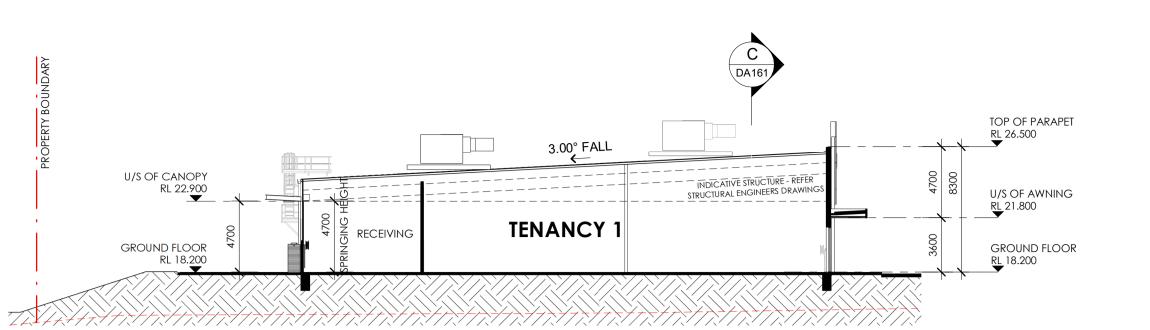

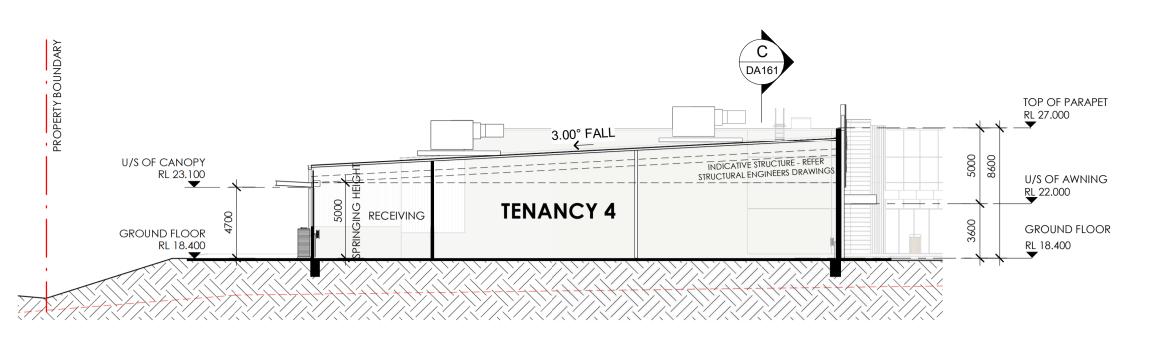


TENANCY 1 - SECTION

DA101 Scale: 1 : 250


B TENANCY 4 - SECTION

DA101 Scale: 1:250

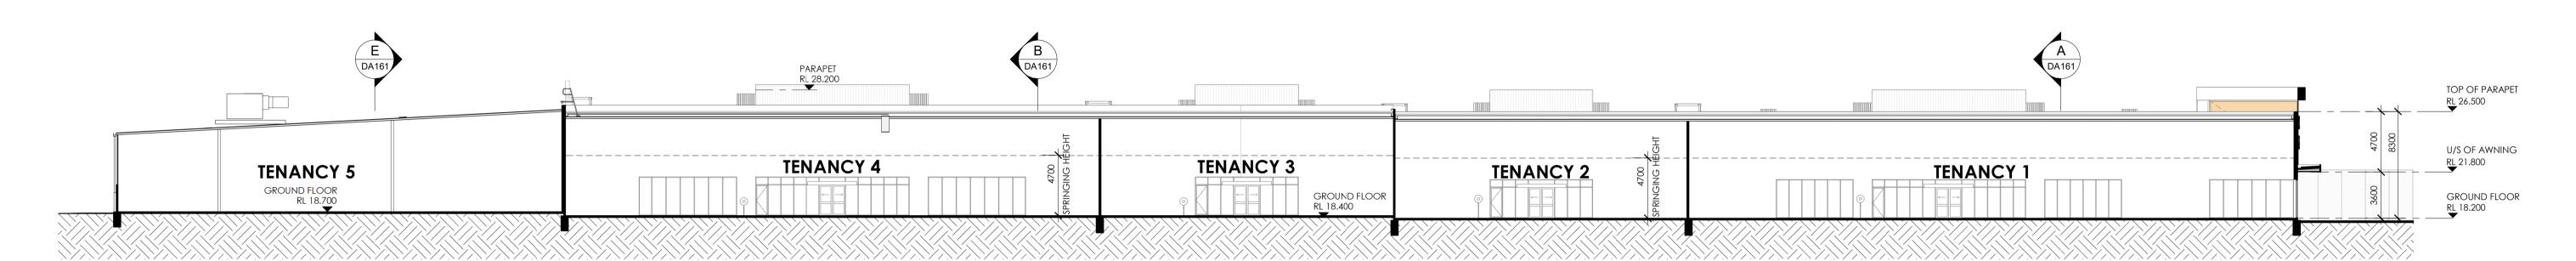


TENANCY 1/4 - SECTION

Scale: 1 : 250

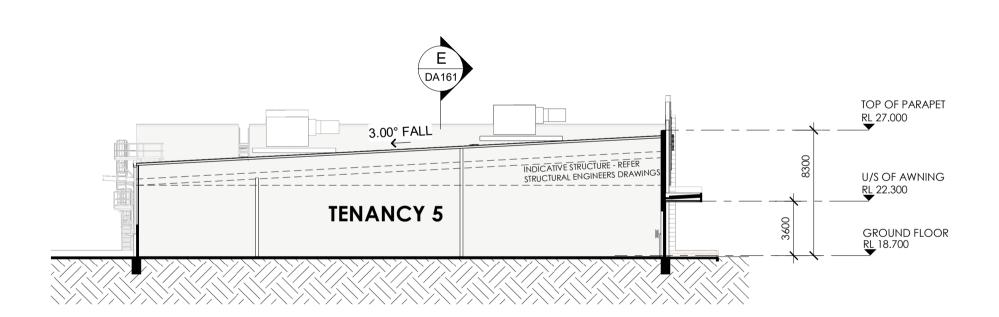


TENANCY 5 - SECTION

DA102 Scale: 1 : 250

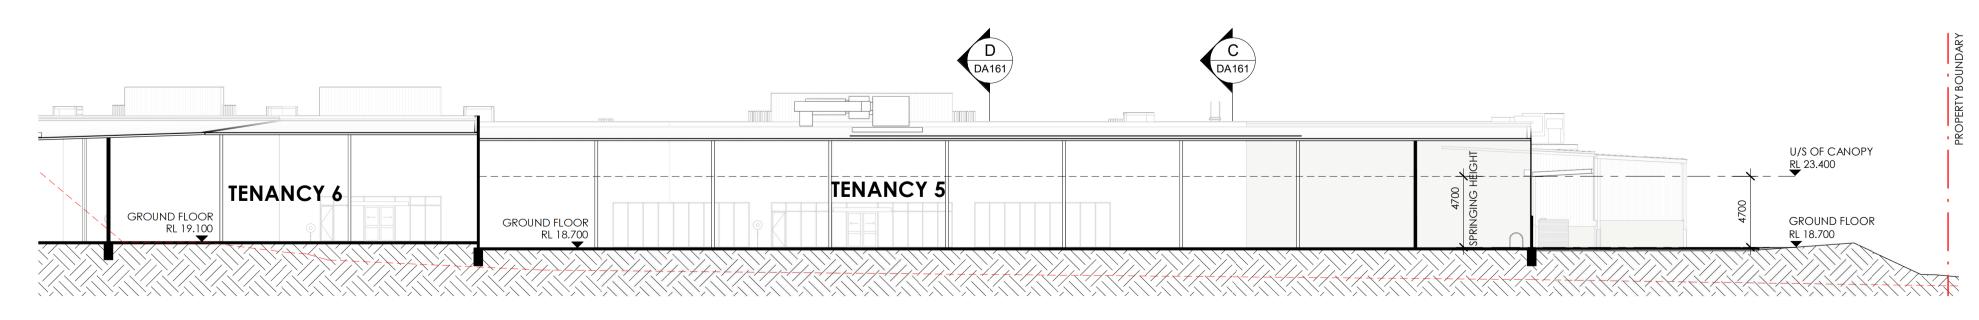

TENANCY 5/6 - LONG SECTION


DA102 Scale: 1:250

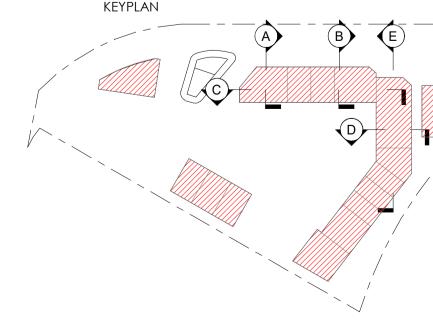

Member
Australian Institute
of Architects

ISSUE AMENDMENT

DATE CHK'D 30.05.25 WG A DEVELOPMENT APPLICATION

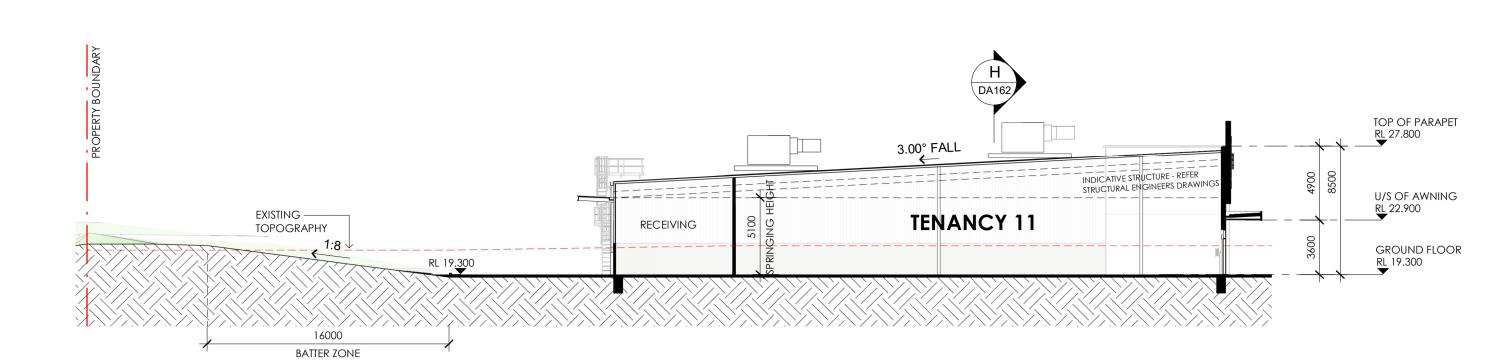



RECEIVING

EXISTING -

TOPOGRAPHY

SWALE (tbc)-

U/S OF CANOPY

GROUND FLOOR

2491 BATTER ZONE


RL 19.100

3.00° FALL

TENANCY 8

INDICATIVE STRUCTURE - REFER STRUCTURAL ENGINEERS DRAWIN



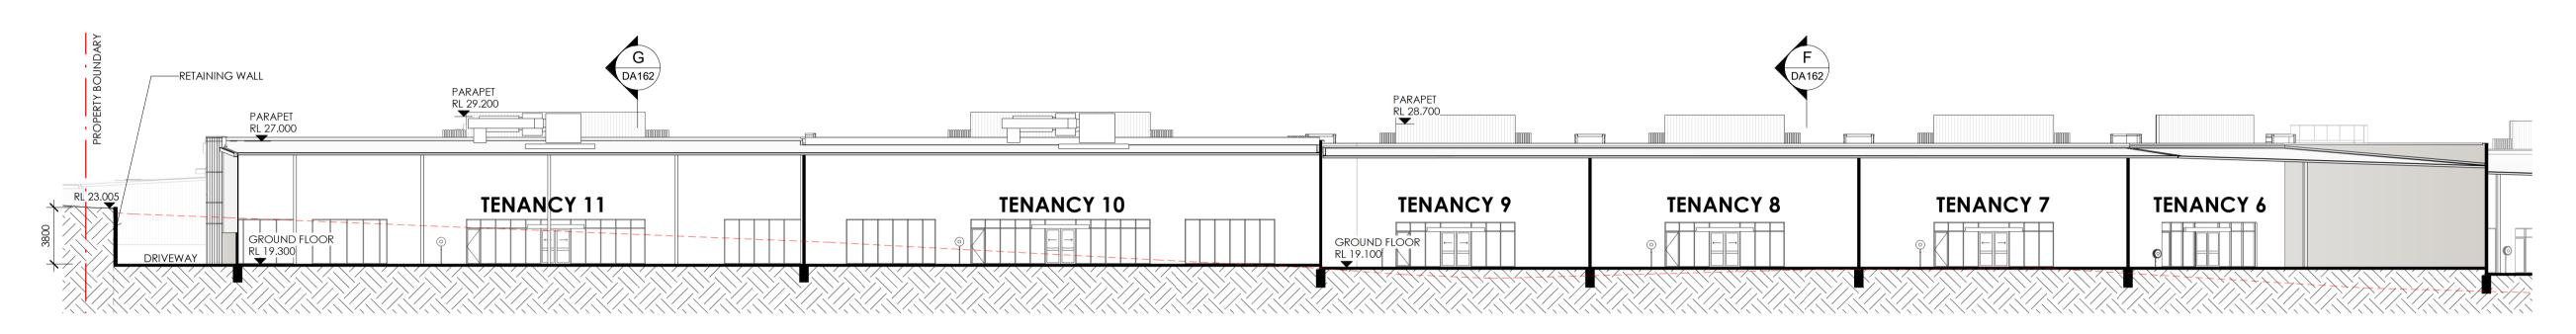

TOP OF PARAPET

U/S OF AWNING

GROUND FLOOR


RL 27.400

RL 22.700

RL 19.100


TENANCY 6/11 - LONG SECTION

Scale: 1:250

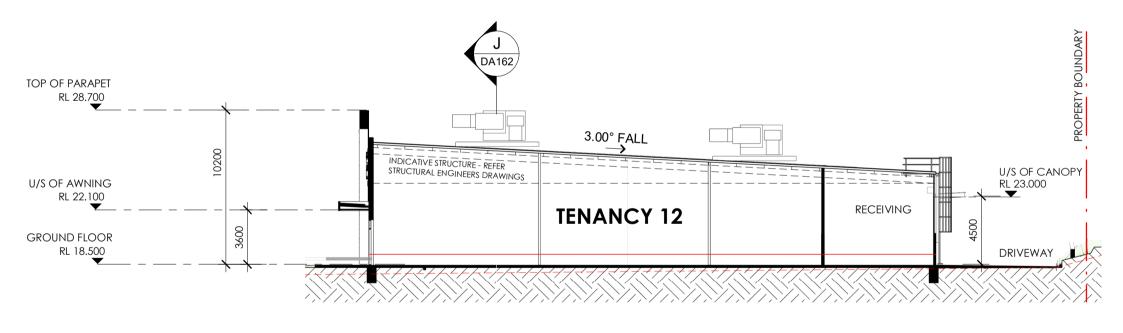



TENANCY 12 - SECTION


DA104 Scale: 1:250

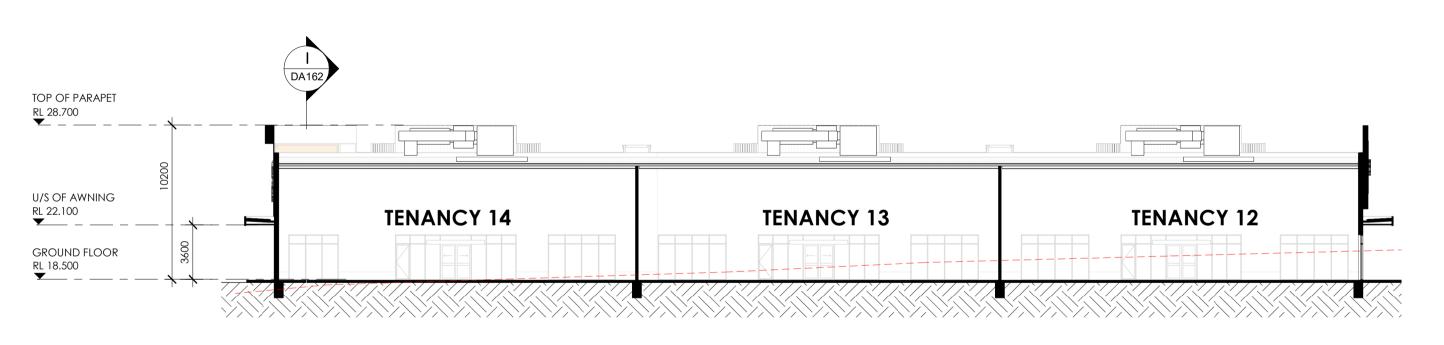

TENANCY 12/13/14 - SECTION DA104 Scale: 1:250

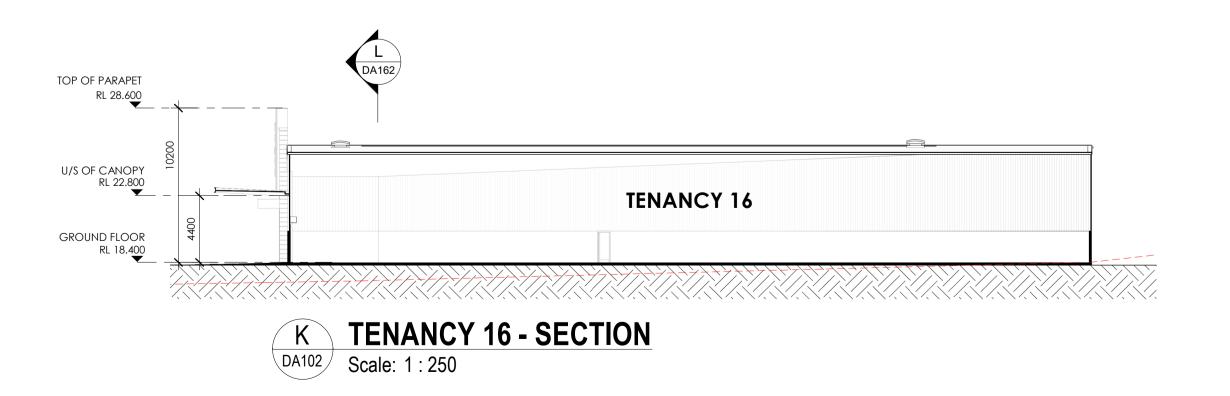


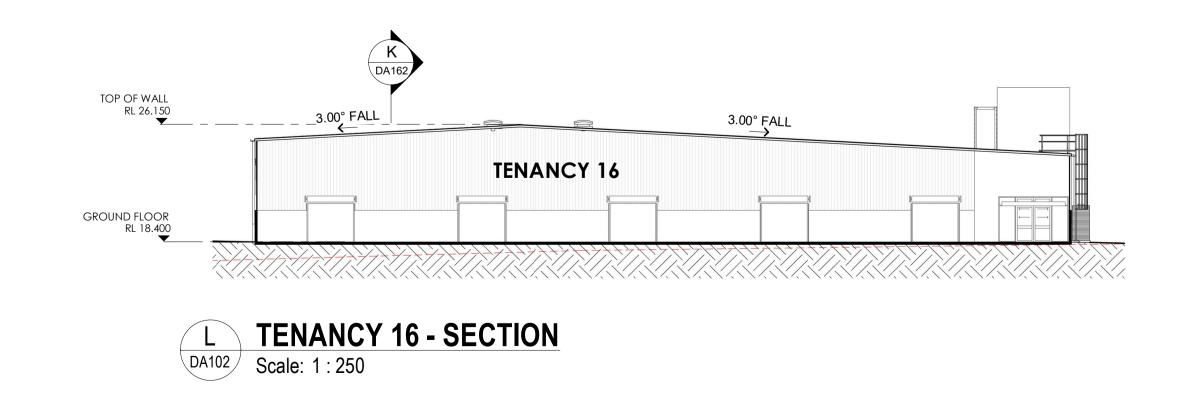

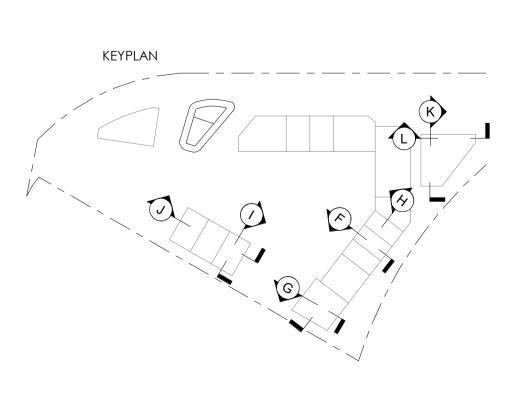


DEVELOPMENT APPLICATION

SECTIONS - SHEET 2

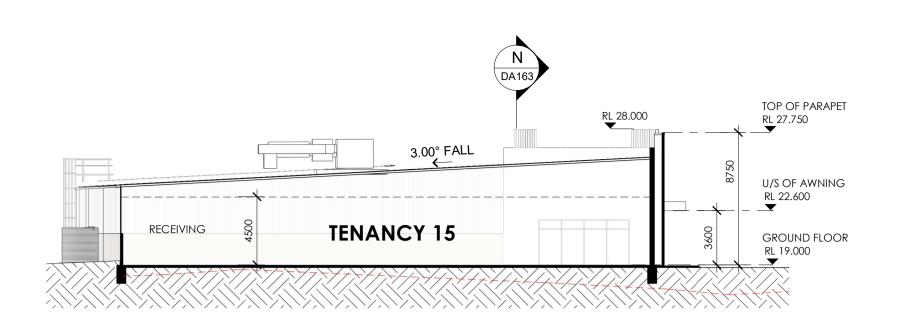

M TENANCY 15 - SECTION - 1

DA104 Scale: 1:250

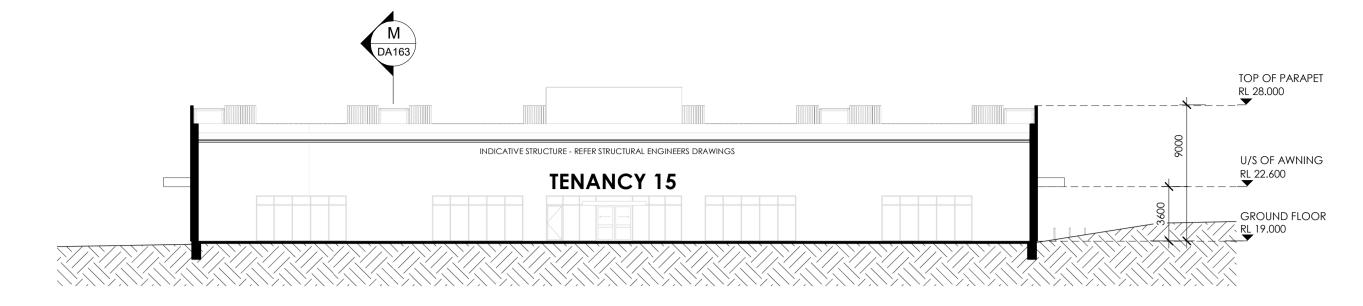

TENANCY 15 - SECTION - 2

Scale: 1:250


THIS DRAWING AND DESIGN IS SUBJECT TO COPYRIGHT AND MAY NOT BE REPRODUCED WITHOUT PRIOR WRITTENCONSENT OF LEFFLER SIMES PTY LTD


DATE CHK'D 30.05.25 WG

ISSUE AMENDMENT
A DEVELOPMENT APPLICATION

DEVELOPMENT APPLICATION

SECTIONS - SHEET 3

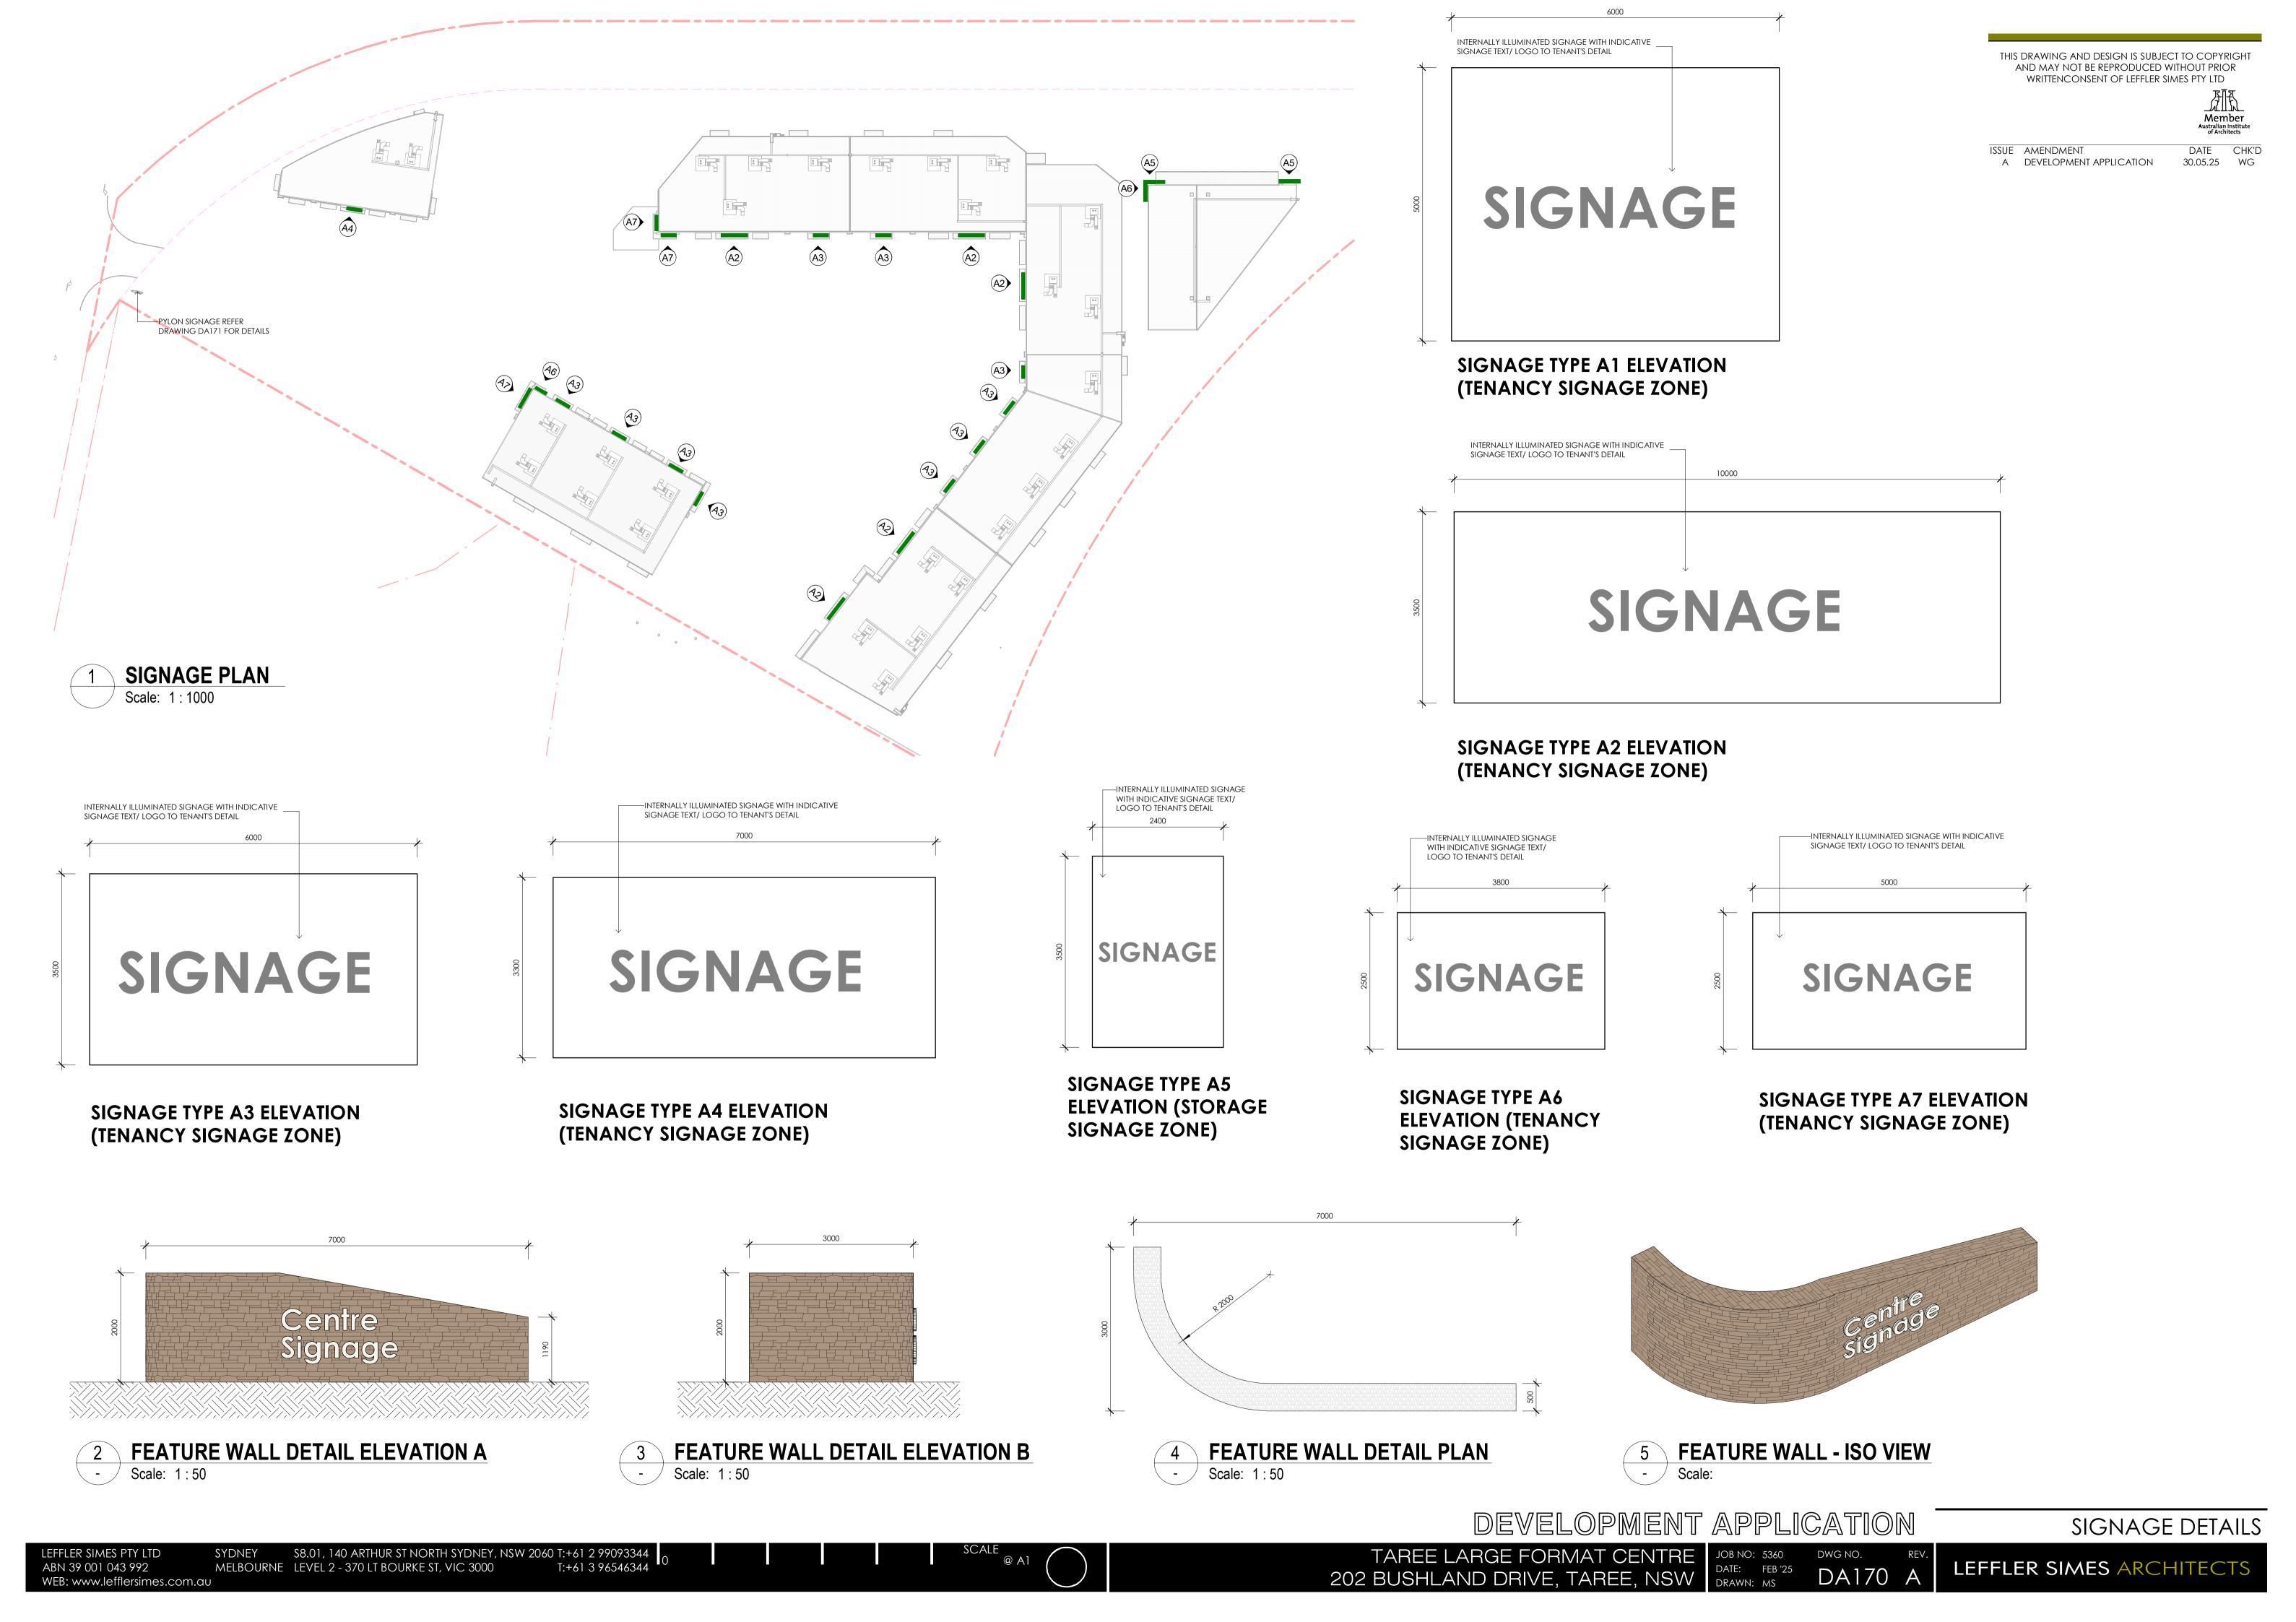

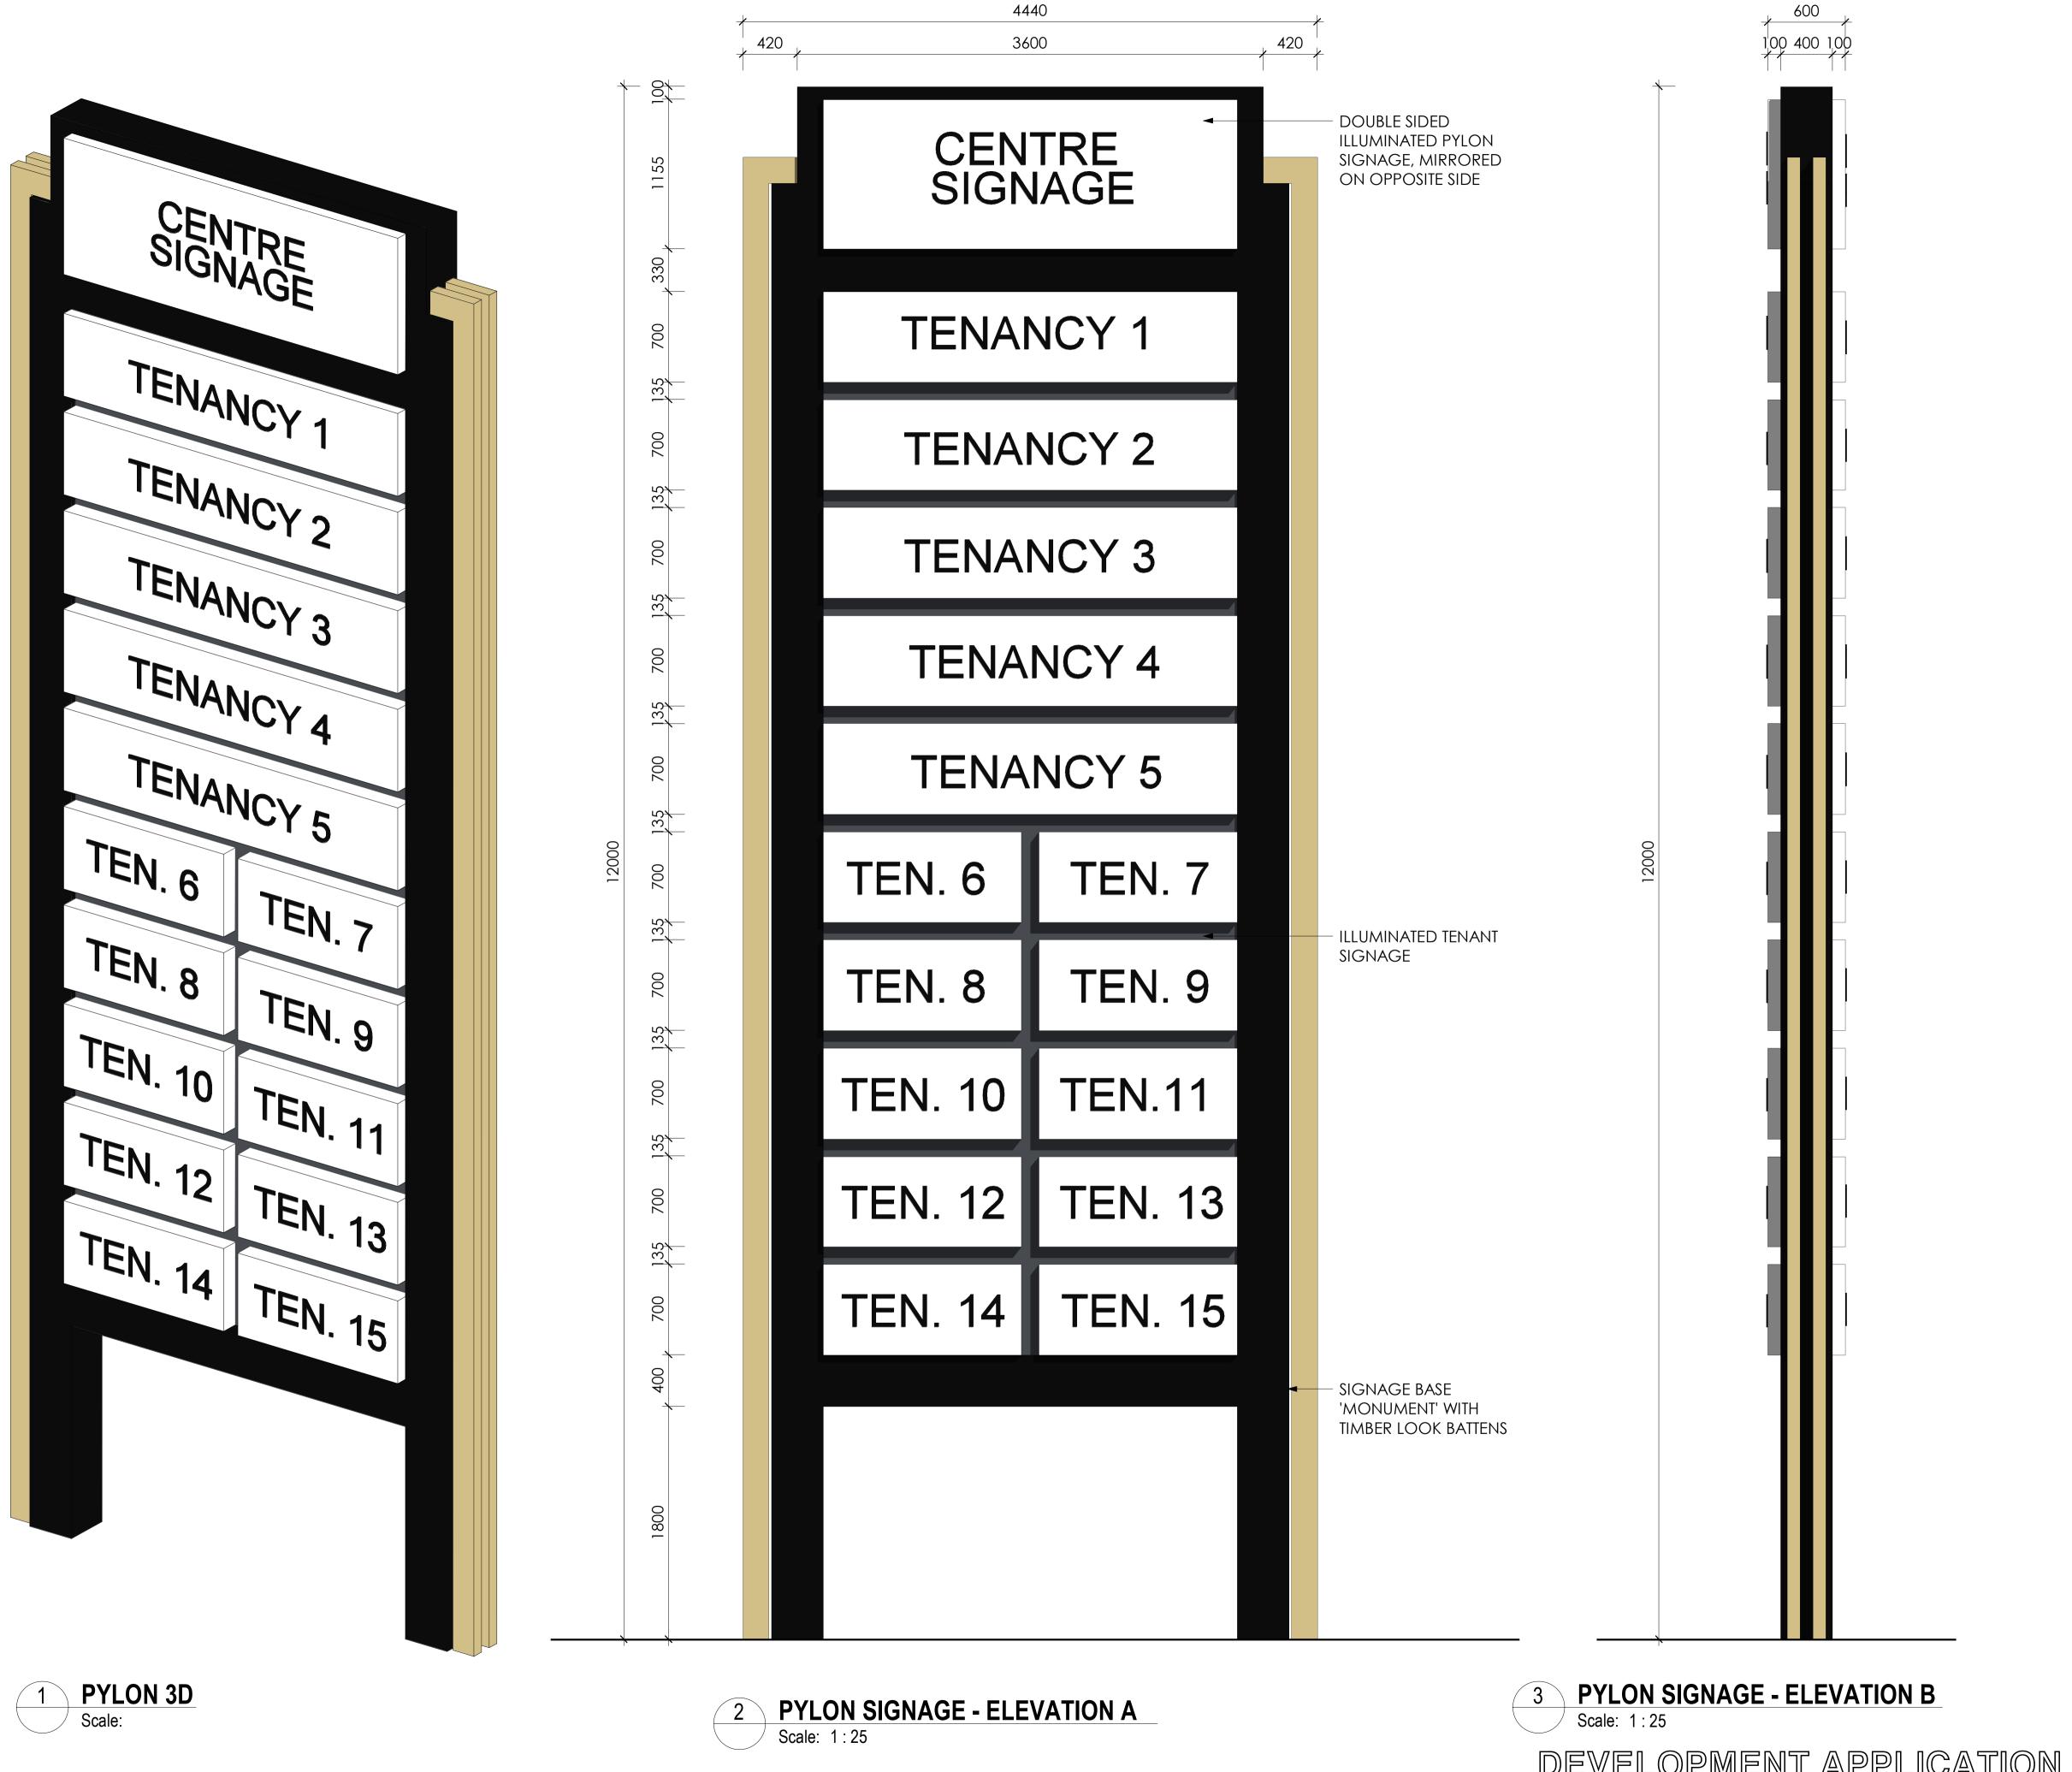

DEVELOPMENT APPLICATION

PYLON DETAILS

THIS DRAWING AND DESIGN IS SUBJECT TO COPYRIGHT AND MAY NOT BE REPRODUCED WITHOUT PRIOR

WRITTENCONSENT OF LEFFLER SIMES PTY LTD

ISSUE AMENDMENT

A DEVELOPMENT APPLICATION

Member
Australian Institute
of Architects

DATE CHK'D 30.05.25 WG

DATE CHK'D 30.05.25 WG






DEVELOPMENT APPLICATION

SHADOW DIAGRAM - 21st Mar 9am

Scale: 1:1500

DATE CHK'D 30.05.25 WG

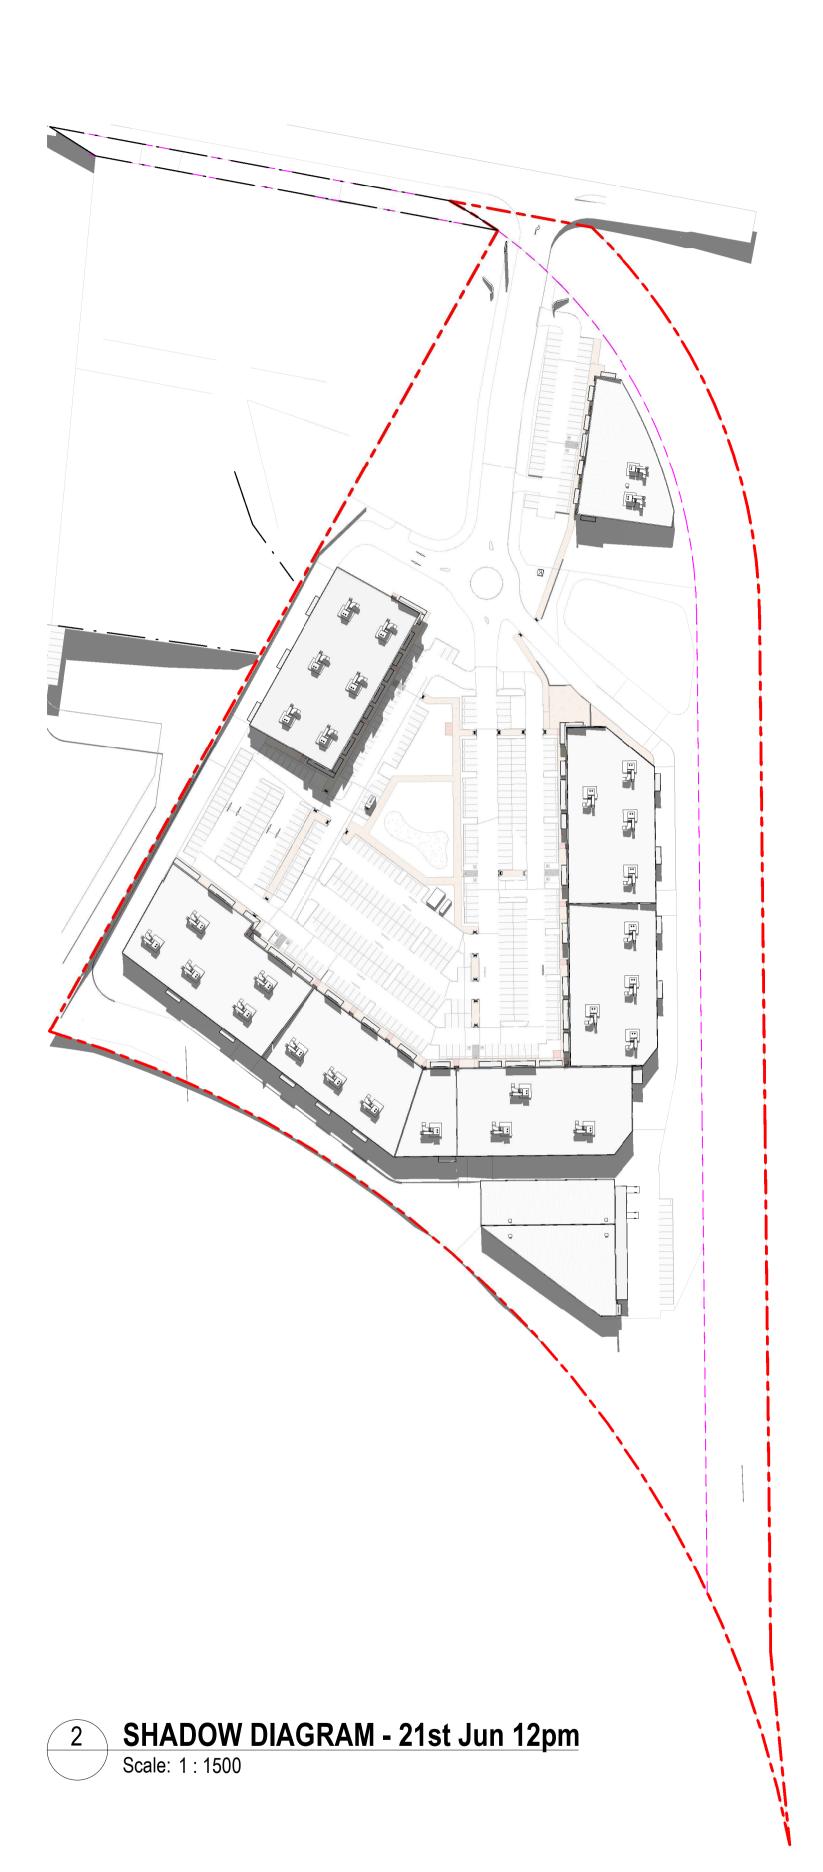



DEVELOPMENT APPLICATION

SHADOW DIAGRAMS

SHADOW DIAGRAM - 21st Jun 9am

Scale: 1:1500



01 - ARTIST IMPRESSION



02 - ARTIST IMPRESSION



03 - ARTIST IMPRESSION



04 - ARTIST IMPRESSION

